

DEPARTMENT OF THE ARMY PERMIT

Permittee: Florida Department of Transportation - District 5
Attn: Patrick Muench
719 S. Woodland Blvd.
Deland, Florida 32720

Permit No: SAJ-1998-4316(IP-AWP)

Issuing Office: U.S. Army Engineer District, Jacksonville

NOTE: The term "you" and its derivatives, as used in this permit, means the permittee or any future transferee. The term "this office" refers to the appropriate district or division office of the Corps of Engineers having jurisdiction over the permitted activity or the appropriate official of that office acting under the authority of the commanding officer.

You are authorized to perform work in accordance with the terms and conditions specified below.

Project Description: Impacts to 2.55 acres of waters of the United States (wetlands) for the widening of 1.7 miles of State Road 530 (US 192) from a four-lane highway to a six-lane highway. Financial Project Number 239304-1-52-01. The work described above is to be completed in accordance with the 3 attachments affixed at the end of this permit instrument.

Project Location: The project is the widening of State Road 530 (US 192) from the Lake County line east to Captain Kidd Blvd, in Sections 5 and 6, Township 25 South, Range 27 East, and Sections 31 and 32, Township 24 South, Range 27 East, Osceola County, Florida. The project as proposed will impact Lake Chapin and wetlands hydrologically connected to Lake Davenport.

Directions to site: From the intersection of US-27 and US 192 (SR 530) proceed east. The project begins near Bali Blvd. and ends at Captain Kidd Road.

Latitude & Longitude: Latitude 28.347 North
Longitude 81.648 West

JACKSONVILLE, FLORIDA
U.S.A.

PERMIT NUMBER: SAJ-1998-4316(IP-AWP)

PERMITTEE: Florida Department of Transportation, District 5

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Permit Conditions

General Conditions:

1. The time limit for completing the work authorized ends on **December 15, 2018**. If you find that you need more time to complete the authorized activity, submit your request for a time extension to this office for consideration at least one month before the above date is reached.

2. You must maintain the activity authorized by this permit in good condition and in conformance with the terms and conditions of this permit. You are not relieved of this requirement if you abandon the permitted activity, although you may make a good faith transfer to a third party in compliance with General Condition 4 below. Should you wish to cease to maintain the authorized activity or should you desire to abandon it without a good faith transfer, you must obtain a modification of this permit from this office, which may require restoration of the area.

3. If you discover any previously unknown historic or archeological remains while accomplishing the activity authorized by this permit, you must immediately notify this office of what you have found. We will initiate the Federal and State coordination required to determine if the remains warrant a recovery effort or if the site is eligible for listing in the National Register of Historic Places.

4. If you sell the property associated with this permit, you must obtain the signature and the mailing address of the new owner in the space provided and forward a copy of the permit to this office to validate the transfer of this authorization.

5. If a conditioned water quality certification has been issued for your project, you must comply with the conditions specified in the certification as special conditions to this permit. For your convenience, a copy of the certification is attached if it contains such conditions.

6. You must allow representatives from this office to inspect the authorized activity at any time deemed necessary to

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ensure that it is being or has been accomplished in accordance with the terms and conditions of your permit.

Special Conditions:

1. **Commencement Notification:** Within 10 days from the date of initiating the authorized work, the Permittee shall provide to the Corps a written notification of the date of commencement of work authorized by this permit.
2. **Fill Material:** The Permittee shall use only clean fill material for this project. The fill material shall be free from items such as trash, debris, automotive parts, asphalt, construction materials, concrete block with exposed reinforcement bars, and soils contaminated with any toxic substance, in toxic amounts in accordance with Section 307 of the Clean Water Act.
3. **Erosion Control:** Prior to the initiation of any work authorized by this permit, the Permittee shall install erosion control measures along the perimeter of all work areas to prevent the displacement of fill material. Immediately after completion of the final grading of the land surface, all slopes, land surfaces, and filled areas adjacent to wetlands shall be stabilized using sod, degradable mats, or a combination of similar stabilizing materials to prevent erosion. The erosion control measures shall remain in place and be maintained until all authorized work has been completed and the site has been stabilized.
4. **Reporting Address:** All reports, documentation and correspondence required by the conditions of this permit shall be submitted to the following address: U.S. Army Corps of Engineers, Regulatory Division, Enforcement Section, P.O. Box 4970, Jacksonville, FL 32232. The Permittee shall reference this permit number, SAJ-1998-4316(IP-AWP), on all submittals.
5. **Mitigation Credit Purchase:** Within 30 days from the date of initiating the authorized work or 12 months from the effective date of this permit, whichever first occurs, the Permittee shall provide verification to the Corps that 0.54 federal mitigation bank credits have been purchased from the Reedy Creek Mitigation

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Bank (SAJ-1995-7852(IP-ME)). The required verification shall reference this project's permit number (SAJ-1998-4316(IP-AWP)).

Note: The Permittee previously mitigated for 2.1 acres of wetland impacts by deducting 34.2 acres from the FFWCC managed Three Lakes Management Area Mitigation (SAJ-1994-3415) site. The Permittee deducted the 34.2 acre/credit withdrawal form the banking ledger on 19 February 1995. The Permittee will continue to utilize the deducted 34.2 acres of compensatory mitigation associated with this project.

6. As-Builts: Within 60 days of completion of the authorized work or at the expiration of the construction window of this permit, whichever occurs first, the Permittee shall submit as-built drawings of the authorized work and a completed As-Built Certification Form (Attachment 4) to the Corps. The drawings shall be signed and sealed by a registered professional engineer and include the following:

a. A plan view drawing of the location of the authorized work footprint (as shown on the permit drawings) with an overlay of the work as constructed in the same scale as the attached permit drawings (8½-inch by 11-inch). The drawing should show all "earth disturbance," including wetland impacts, water management structures, and any on-site mitigation areas.

b. List any deviations between the work authorized by this permit and the work as constructed. In the event that the completed work deviates, in any manner, from the authorized work, describe on the As-Built Certification Form the deviations between the work authorized by this permit and the work as constructed. Clearly indicate on the as-built drawings any deviations that have been listed. Please note that the depiction and/or description of any deviations on the drawings and/or As-Built Certification Form does not constitute approval of any deviations by the U.S. Army Corps of Engineers.

c. The Department of the Army Permit number.

d. Include pre- and post-construction aerial photographs of the project site, if available.

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Further Information:

1. Congressional Authorities: You have been authorized to undertake the activity described above pursuant to:

() Section 10 of the Rivers and Harbors Act of 1899 (33 U.S.C. 403).

(X) Section 404 of the Clean Water Act (33 U.S.C. 1344).

() Section 103 of the Marine Protection, Research and Sanctuaries Act of 1972 (33 U.S.C. 1413).

2. Limits of this authorization.

a. This permit does not obviate the need to obtain other Federal, State, or local authorizations required by law.

b. This permit does not grant any property rights or exclusive privileges.

c. This permit does not authorize any injury to the property or rights of others.

d. This permit does not authorize interference with any existing or proposed Federal projects.

3. Limits of Federal Liability. In issuing this permit, the Federal Government does not assume any liability for the following:

a. Damages to the permitted project or uses thereof as a result of other permitted or unpermitted activities or from natural causes.

b. Damages to the permitted project or uses thereof as a result of current or future activities undertaken by or on behalf of the United States in the public interest.

c. Damages to persons, property, or to other permitted or unpermitted activities or structures caused by the activity authorized by this permit.

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d. Design or construction deficiencies associated with the permitted work.

e. Damage claims associated with any future modification, suspension, or revocation of this permit.

4. Reliance on Applicant's Data: The determination of this office that issuance of this permit is not contrary to the public interest was made in reliance on the information you provided.

5. Reevaluation of Permit Decision: This office may reevaluate its decision on this permit at any time the circumstances warrant. Circumstances that could require a reevaluation include, but are not limited to, the following:

a. You fail to comply with the terms and conditions of this permit.

b. The information provided by you in support of your permit application proves to have been false, incomplete, or inaccurate (see 4 above).

c. Significant new information surfaces which this office did not consider in reaching the original public interest decision.

Such a reevaluation may result in a determination that it is appropriate to use the suspension, modification, and revocation procedures contained in 33 CFR 325.7 or enforcement procedures such as those contained in 33 CFR 326.4 and 326.5. The referenced enforcement procedures provide for the issuance of an administrative order requiring you comply with the terms and conditions of your permit and for the initiation of legal action where appropriate. You will be required to pay for any corrective measures ordered by this office, and if you fail to comply with such directive, this office may in certain situations (such as those specified in 33 CFR 209.170) accomplish the corrective measures by contract or otherwise and bill you for the cost.

6. Extensions: General Condition 1 establishes a time limit for the completion of the activity authorized by this

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permit. Unless there are circumstances requiring either a prompt completion of the authorized activity or a reevaluation of the public interest decision, the Corps will normally give favorable consideration to a request for an extension of this time limit.

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Your signature below, as permittee, indicates that you accept and agree to comply with the terms and conditions of this permit.



(PERMITTEE)

12/18/08

(DATE)



(PERMITTEE NAME-PRINTED)

This permit becomes effective when the Federal official, designated to act for the Secretary of the Army, has signed below.



(DISTRICT ENGINEER)

Paul L. Grosskruger
Colonel, U.S. Army
District Commander

12/23/08

(DATE)

PERMIT NUMBER: SAJ-1998-4316(IP-AWP)

PERMITTEE: Florida Department of Transportation, District 5

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When the structures or work authorized by this permit are still in existence at the time the property is transferred, the terms and conditions of this permit will continue to be binding on the new owner(s) of the property. To validate the transfer of this permit and the associated liabilities associated with compliance with its terms and conditions, have the transferee sign and date below.

(TRANSFeree-SIGNATURE)

(DATE)

(NAME-PRINTED)

(ADDRESS)

(CITY, STATE, AND ZIP CODE)

PERMIT NUMBER: SAJ-1998-4316(IP-AWP)

PERMITTEE: Florida Department of Transportation, District 5

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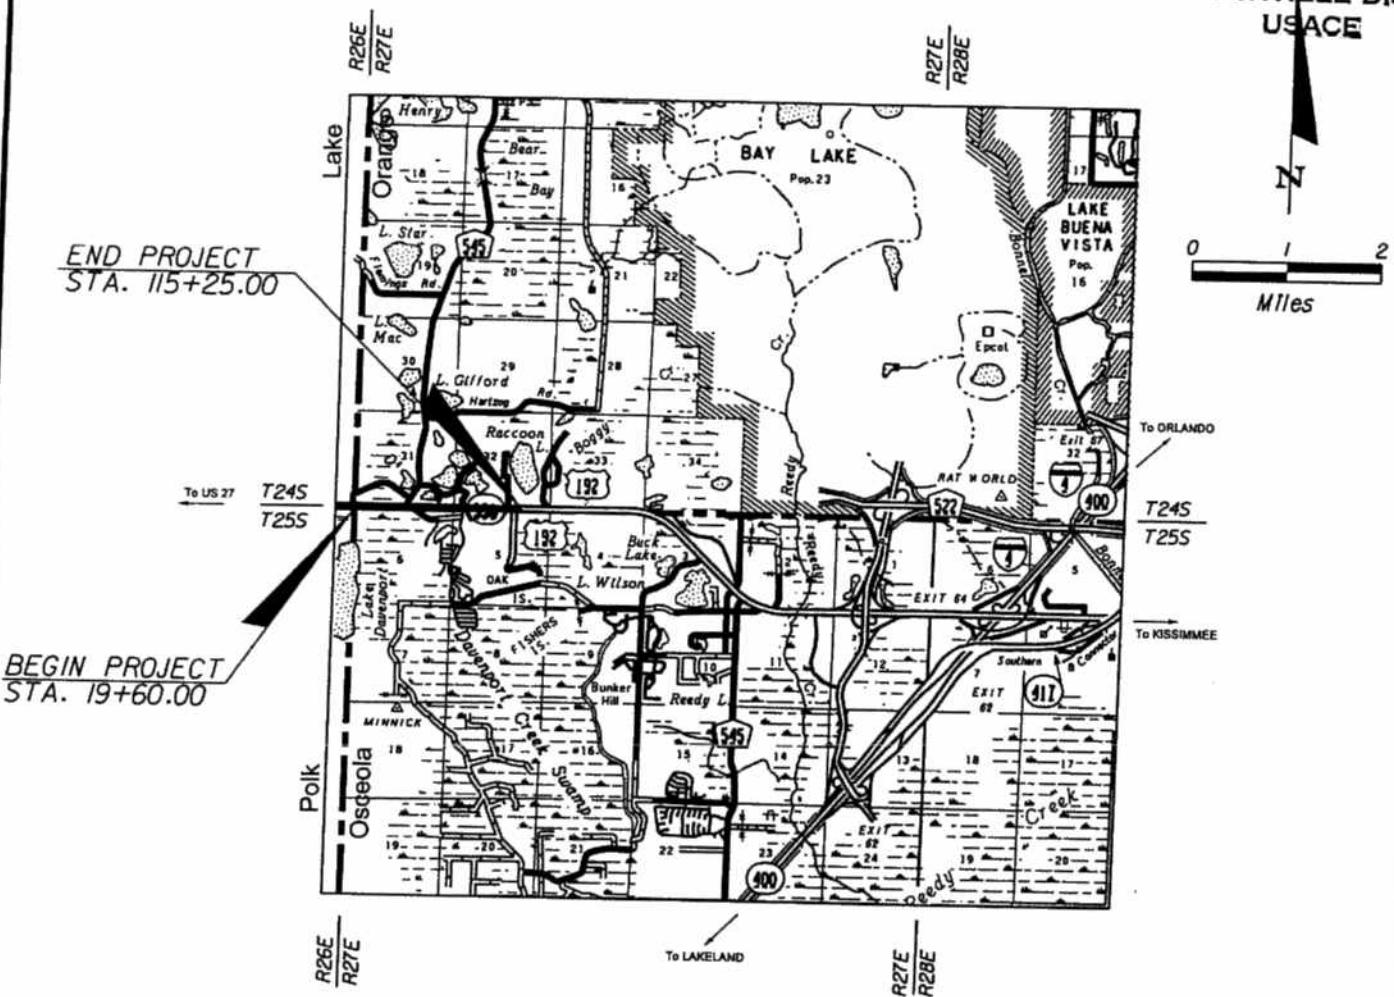
***Attachments to Department of the Army
Permit Number SAJ-1998-4316(IP-AWP)***

1. PERMIT DRAWINGS: 23 pages, dated April 7, 2008
2. WATER QUALITY CERTIFICATION: Specific Conditions of the water quality permit/certification in accordance with General Condition number 5 on page 2 of this DA permit. 7 pages.
3. AS-BUILT CERTIFICATION FORM: 1 page

RECEIVED

APR 10 2008

JACKSONVILLE DISTRICT
USACE



INDEX OF PLANS

SHEET NO.

- 1
- 2
- 3-11
- 12-22
- 23

SHEET DESCRIPTION

- LOCATION MAP
- PLAN SHEET LAYOUT
- PLAN SHEETS
- CROSS SECTIONS
- WETLAND IMPACTS SUMMARY TABLE

PLANS PREPARED BY:

CH2MHILL

225 E. ROBINSON STREET, SUITE 505
ORLANDO, FLORIDA 32801-4322

U.S. Army Corps of Engineers

Permit # SAT-1998-4316

Date: 12/15/08

Attachment: 1

APPLICANT: FLORIDA DEPARTMENT OF TRANSPORTATION
(DISTRICT FIVE)

PROJECT: STATE ROAD NO. 530 WIDENING

LOCATION: ORANGE COUNTY OF FLORIDA

DATUM: NGVD 1929

Karen Acree Snyder
Signed: Karen Acree Snyder
P.E. No. 47762

CH2MHILL
225 E. Robinson Street Suite 505
Orlando, FL 32801
License No. 0000Y2

DREDGE/FILL DETAILS

PURPOSE: WETLAND IMPACTS

SECTIONS: 31, 32 T24S R27E

SECTIONS: 5, 6 T25S R27E

ORANGE-OSCEOLA COUNTY

DATE: APRIL 07, 2008

sheet no. 1 of 23

FLORIDA LAND USE, COVER AND FORMS CLASSIFICATION SYSTEM (FLUCFCS) CODES

UPLANDS


- | | WETLANDS |
|-----|---|
| 109 | Urban and Built-up, Under Construction |
| 110 | Residential (Low Density) |
| 140 | Commercial and Services |
| 193 | Urban Land in Transition without Positive Indication of Intended Activity |
| 412 | Longleaf Pine-Xeric Oak |
| 414 | Pine - Mesic Oak |
| 421 | Xeric Oak |
| 434 | Hardwood (Coniferous Mixed) |

UPLANDS

- | | WETLANDS |
|-----|-------------------------------|
| 511 | Ditch |
| 523 | Lakes larger than 10 acres |
| 524 | Lakes less than 10 acres |
| 534 | Reservoirs less than 10 acres |
| 611 | Bay Swamps |
| 618 | Willow and Elderberry |
| 641 | Freshwater Marshes |
| 814 | Roads and Highways |

BEG PROJECT
ORANGE/LAKE COUNTY LINE
STA 19+50.00

Orange County

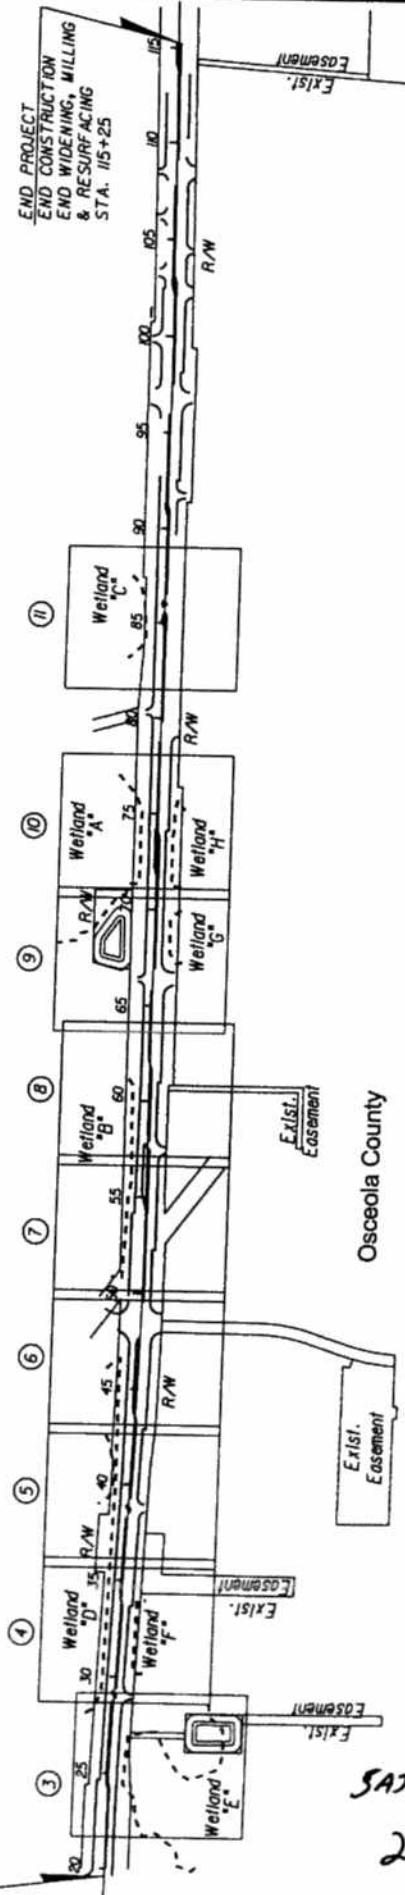

SAT-1998-4316
2 of 14

APPLICANT: FLORIDA DEPARTMENT OF TRANSPORTATION
(DISTRICT FIVE)

PROJECT: STATE ROAD NO. 530 WIDENING

LOCATION: ORANGE COUNTY OF FLORIDA

DATUM: NGVD 1929


SIGNER: Karen Acosta, P.E. No. 47762
CH2MHILL
225 E. Robinson Street, Suite 505
Orlando, FL 32801
License No. 0000072

DREDGE/FILL DETAILS
PURPOSE: WETLAND IMPACTS
SECTIONS: 31, 32 T24S R27E
SECTIONS: 5, 6 T25S R27E
ORANGE-OSCEOLA COUNTY
DATE: APRIL 07, 2008
SHEET NO. 2 OF 23

4/3/2008 3:42:08 PM D:\Program Files\AutoCAD 2004\1-Year\Millennium\FLUCFCS.dwg

April 8, 08

PLAN SHEET LAYOUT

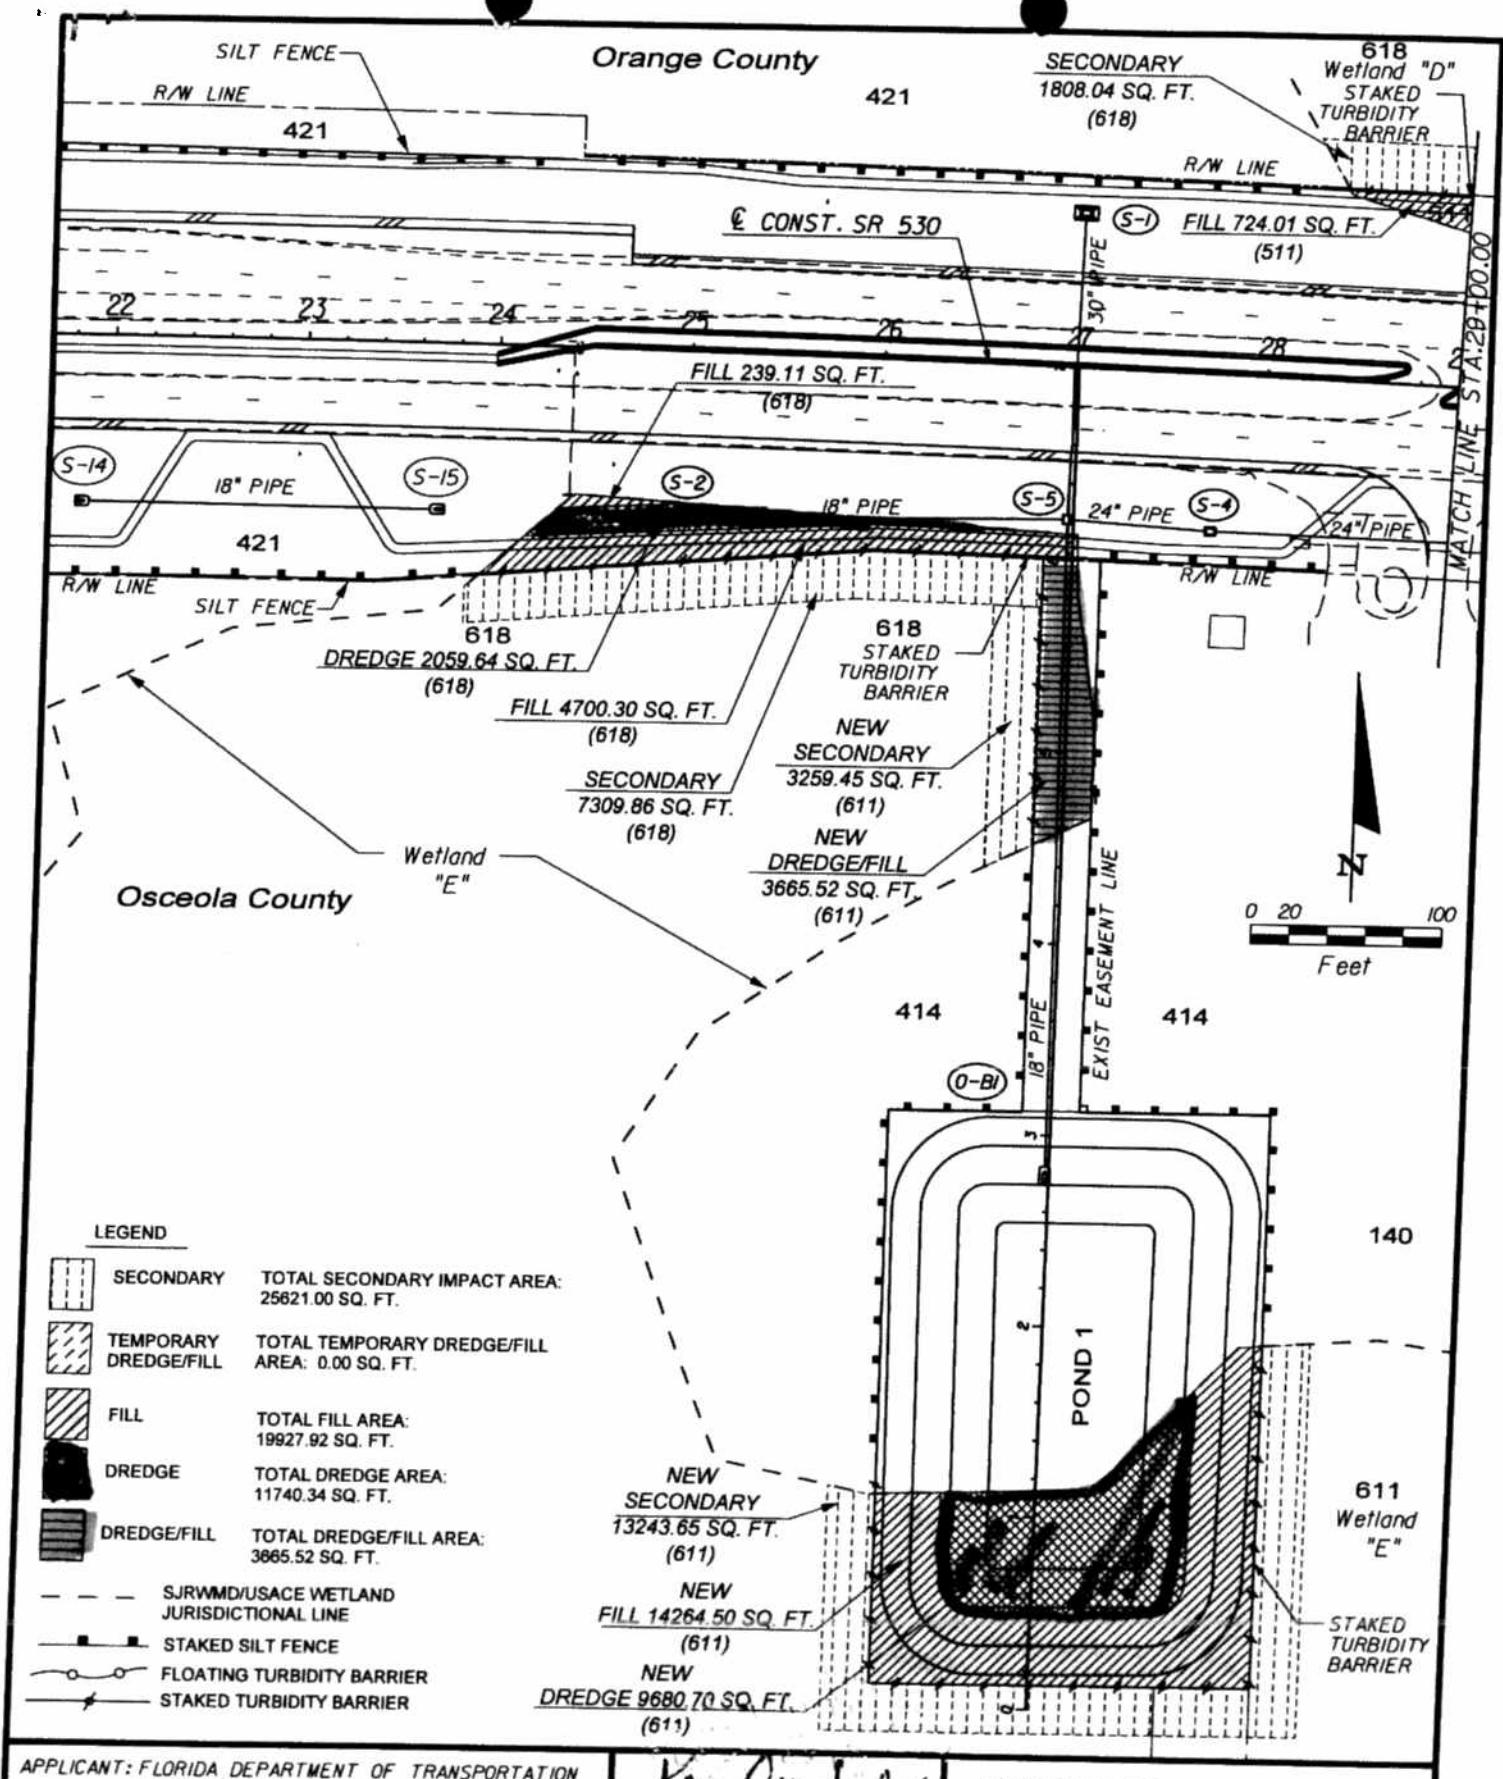

APPLICANT: FLORIDA DEPARTMENT OF TRANSPORTATION
(DISTRICT FIVE)

PROJECT: STATE ROAD NO. 530 WIDENING


LOCATION: ORANGE COUNTY OF FLORIDA

DATUM: NGVD 1929

Karen A. Snyder
Signed: Karen A. Snyder
P.E. NO. 47762

CH2MHILL
225 E. Robinson Street Suite 505
Orlando, FL 32801
License No. 000072

DREDGE/FILL DETAILS
PURPOSE: WETLAND IMPACTS
SECTIONS: 31, 32 T24S R27E
SECTIONS: 5, 6 T25S R27E
ORANGE-OSCEOLA COUNTY
DATE: APRIL 07, 2008
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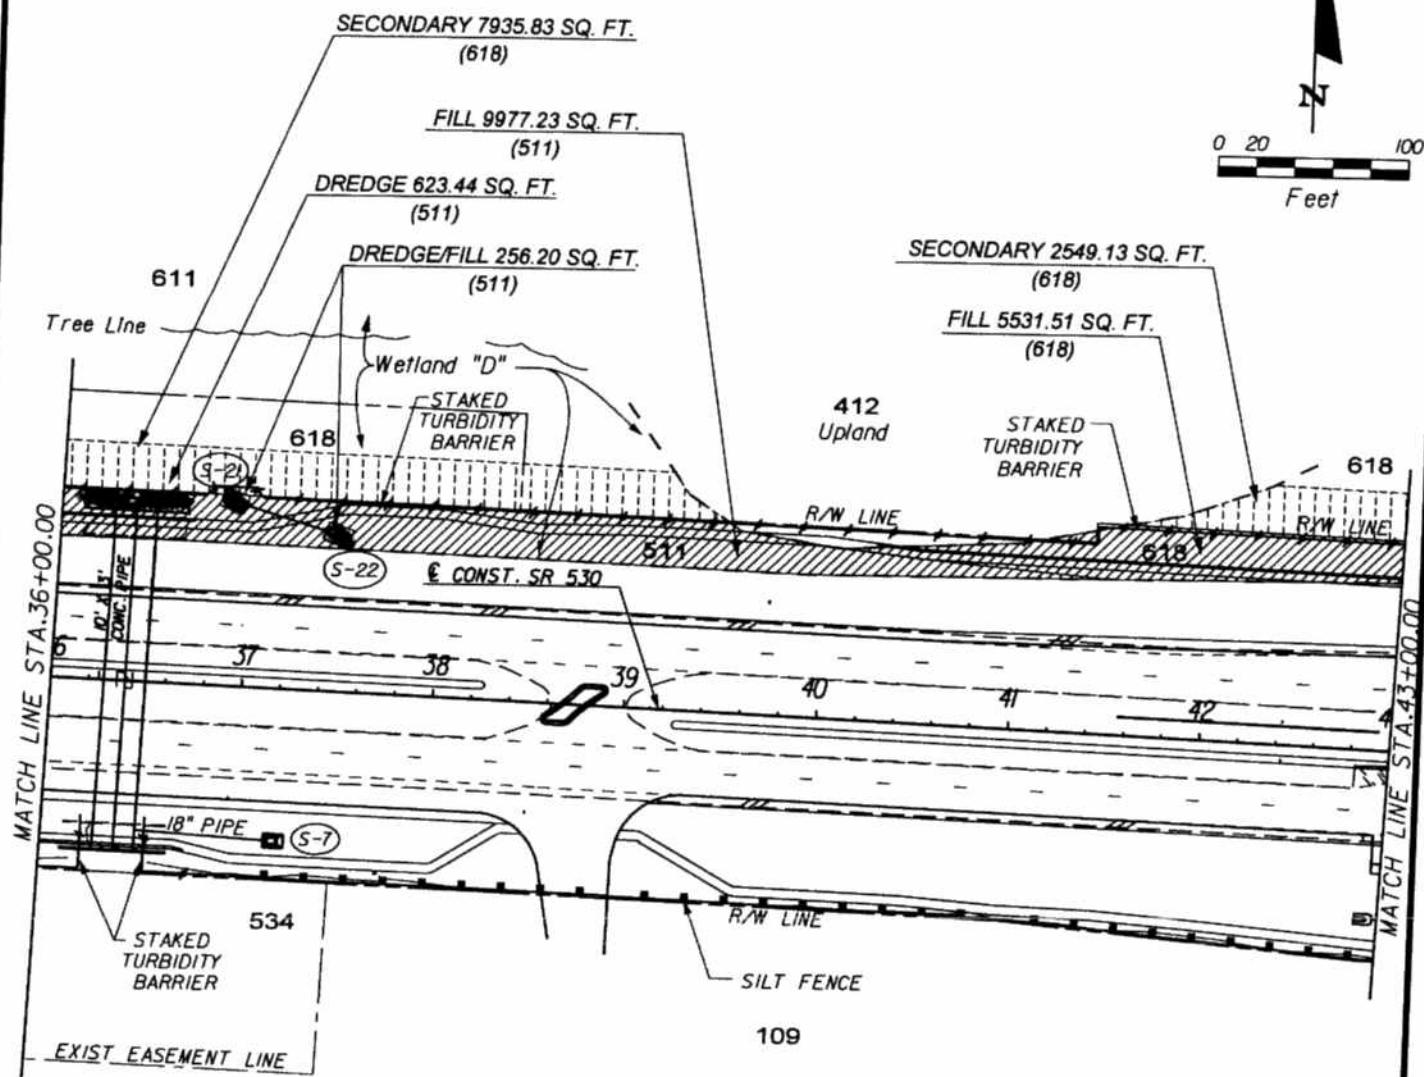


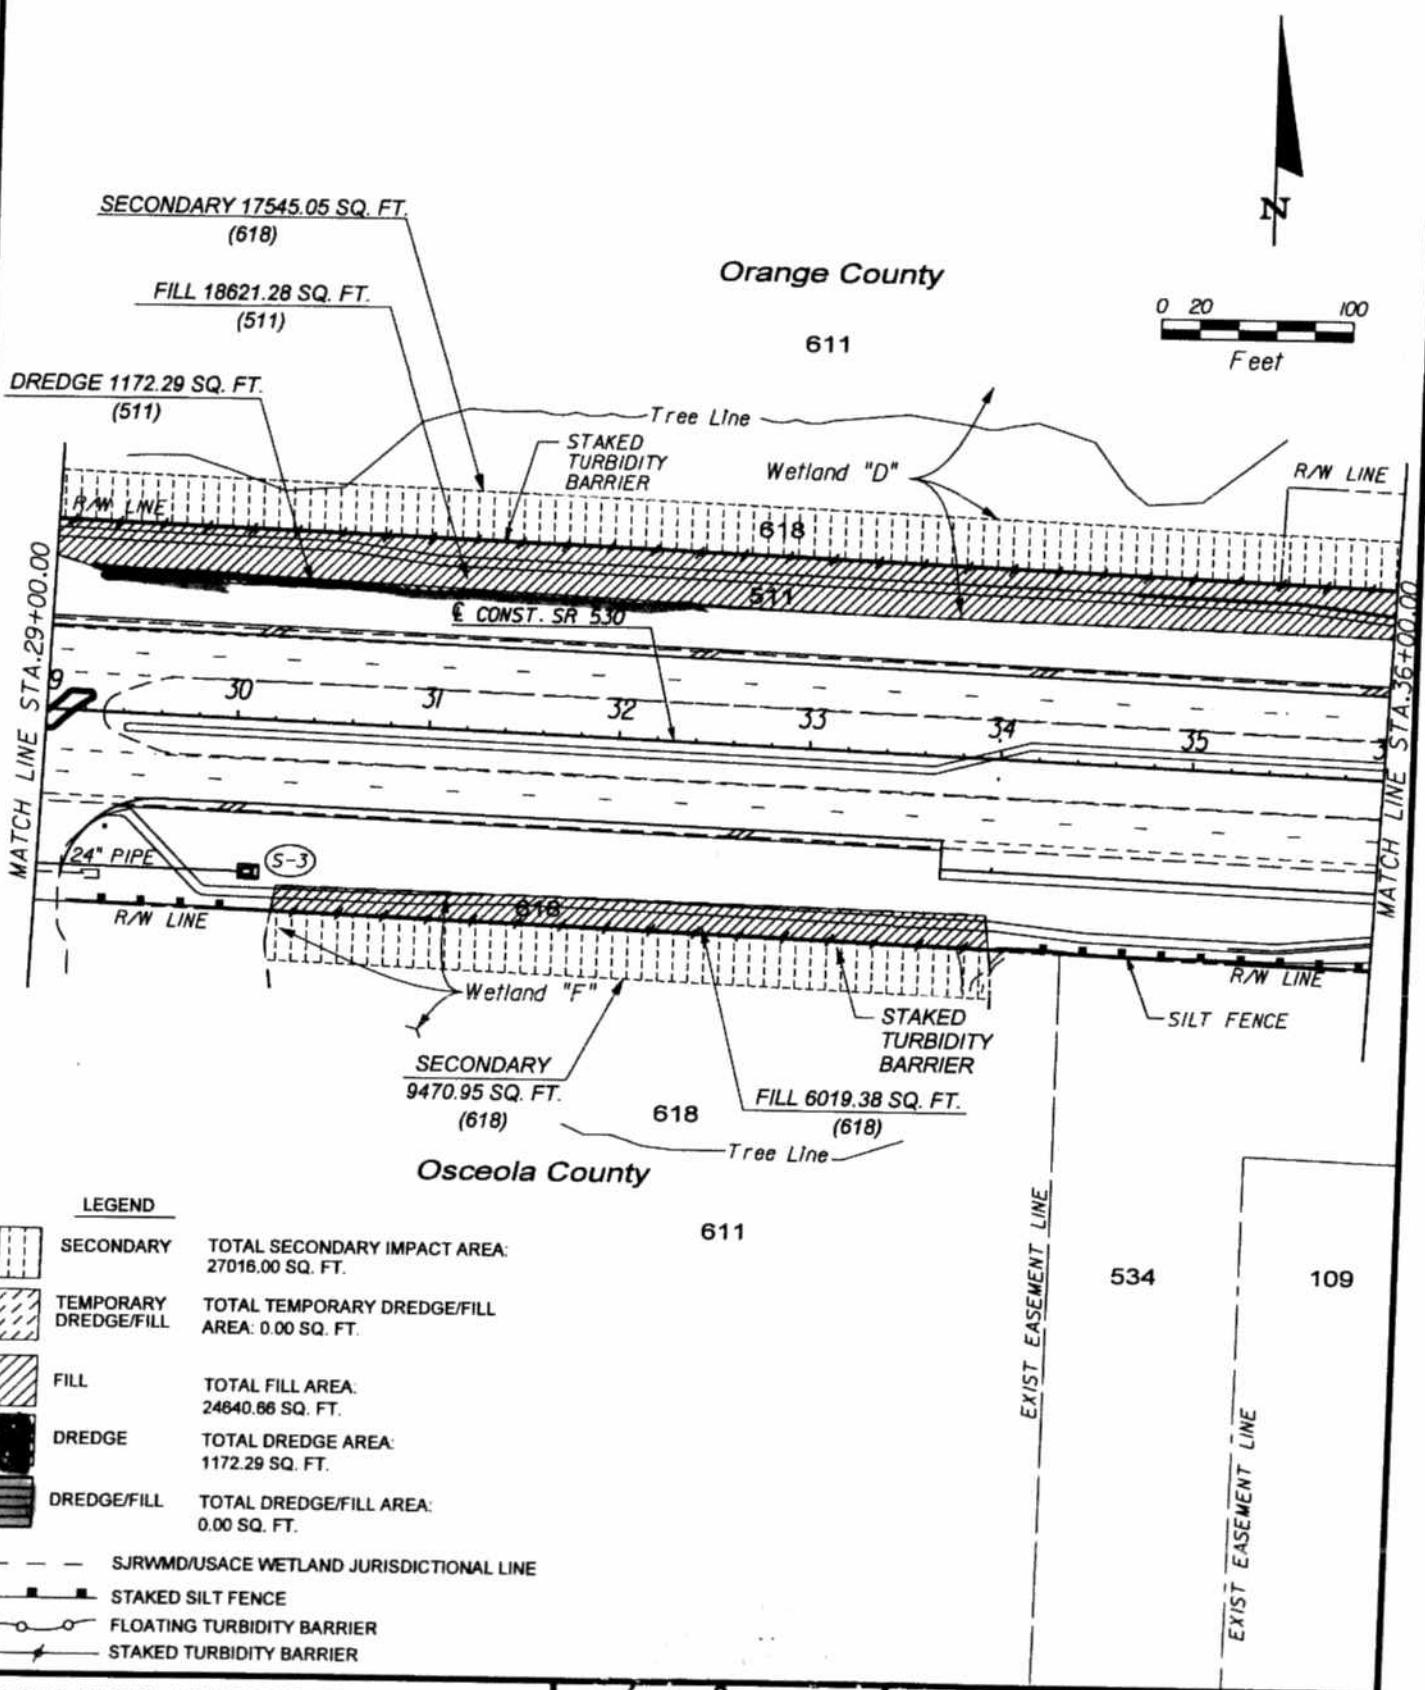APPLICANT: FLORIDA DEPARTMENT OF TRANSPORTATION
(DISTRICT FIVE)
PROJECT: STATE ROAD NO. 530 WIDENING
LOCATION: ORANGE COUNTY OF FLORIDA
DATUM: NGVD 1929

Karen Acree Snyder
Signed: Karen Acree Snyder
F.E. NO. 47762
CH2MHILL
225 E. Robinson Street Suite 505
Orlando, FL 32804
License No. 000072

DREDGE/FILL DETAILS
PURPOSE: WETLAND IMPACTS
SECTIONS: 31, 32 T24S R27E
SECTIONS: 5, 6 T25S R27E
ORANGE-OSCEOLA COUNTY
DATE: APRIL 07, 2008
SHEET NO. 4 OF 23

Orange County



Osceola County

LEGEND

- SECONDARY TOTAL SECONDARY IMPACT AREA: 10484.96 SQ. FT.
- TEMPORARY DREDGE/FILL TOTAL TEMPORARY DREDGE/FILL AREA: 0.00 SQ. FT.
- FILL TOTAL FILL AREA: 15508.74 SQ. FT.
- DREDGE TOTAL DREDGE AREA: 623.44 SQ. FT.
- DREDGE/FILL TOTAL DREDGE/FILL AREA: 256.20 SQ. FT.
- SJRWMD/USACE WETLAND JURISDICTIONAL LINE
- STAKED SILT FENCE
- FLOATING TURBIDITY BARRIER
- STAKED TURBIDITY BARRIER

APPLICANT: FLORIDA DEPARTMENT OF TRANSPORTATION
(DISTRICT FIVE)
PROJECT: STATE ROAD NO. 530 WIDENING
LOCATION: ORANGE COUNTY OF FLORIDA
DATUM: NGVD 1929

Karen Acra Snyder
Signed: Karen Acra Snyder
P.E. No. 47762
CH2MHILL
225 E. Robinson Street, Suite 505
Orlando, FL 32801
License No. 000072


DREDGE/FILL DETAILS
PURPOSE: WETLAND IMPACTS
SECTIONS: 31, 32 T24S R27E
SECTIONS: 5, 6 T25S R27E
ORANGE - OSCEOLA COUNTY
DATE: APRIL 07, 2008
SHEET NO. 5 OF 23

#DATE#

#TIME#

#FILE#

August 5, 08

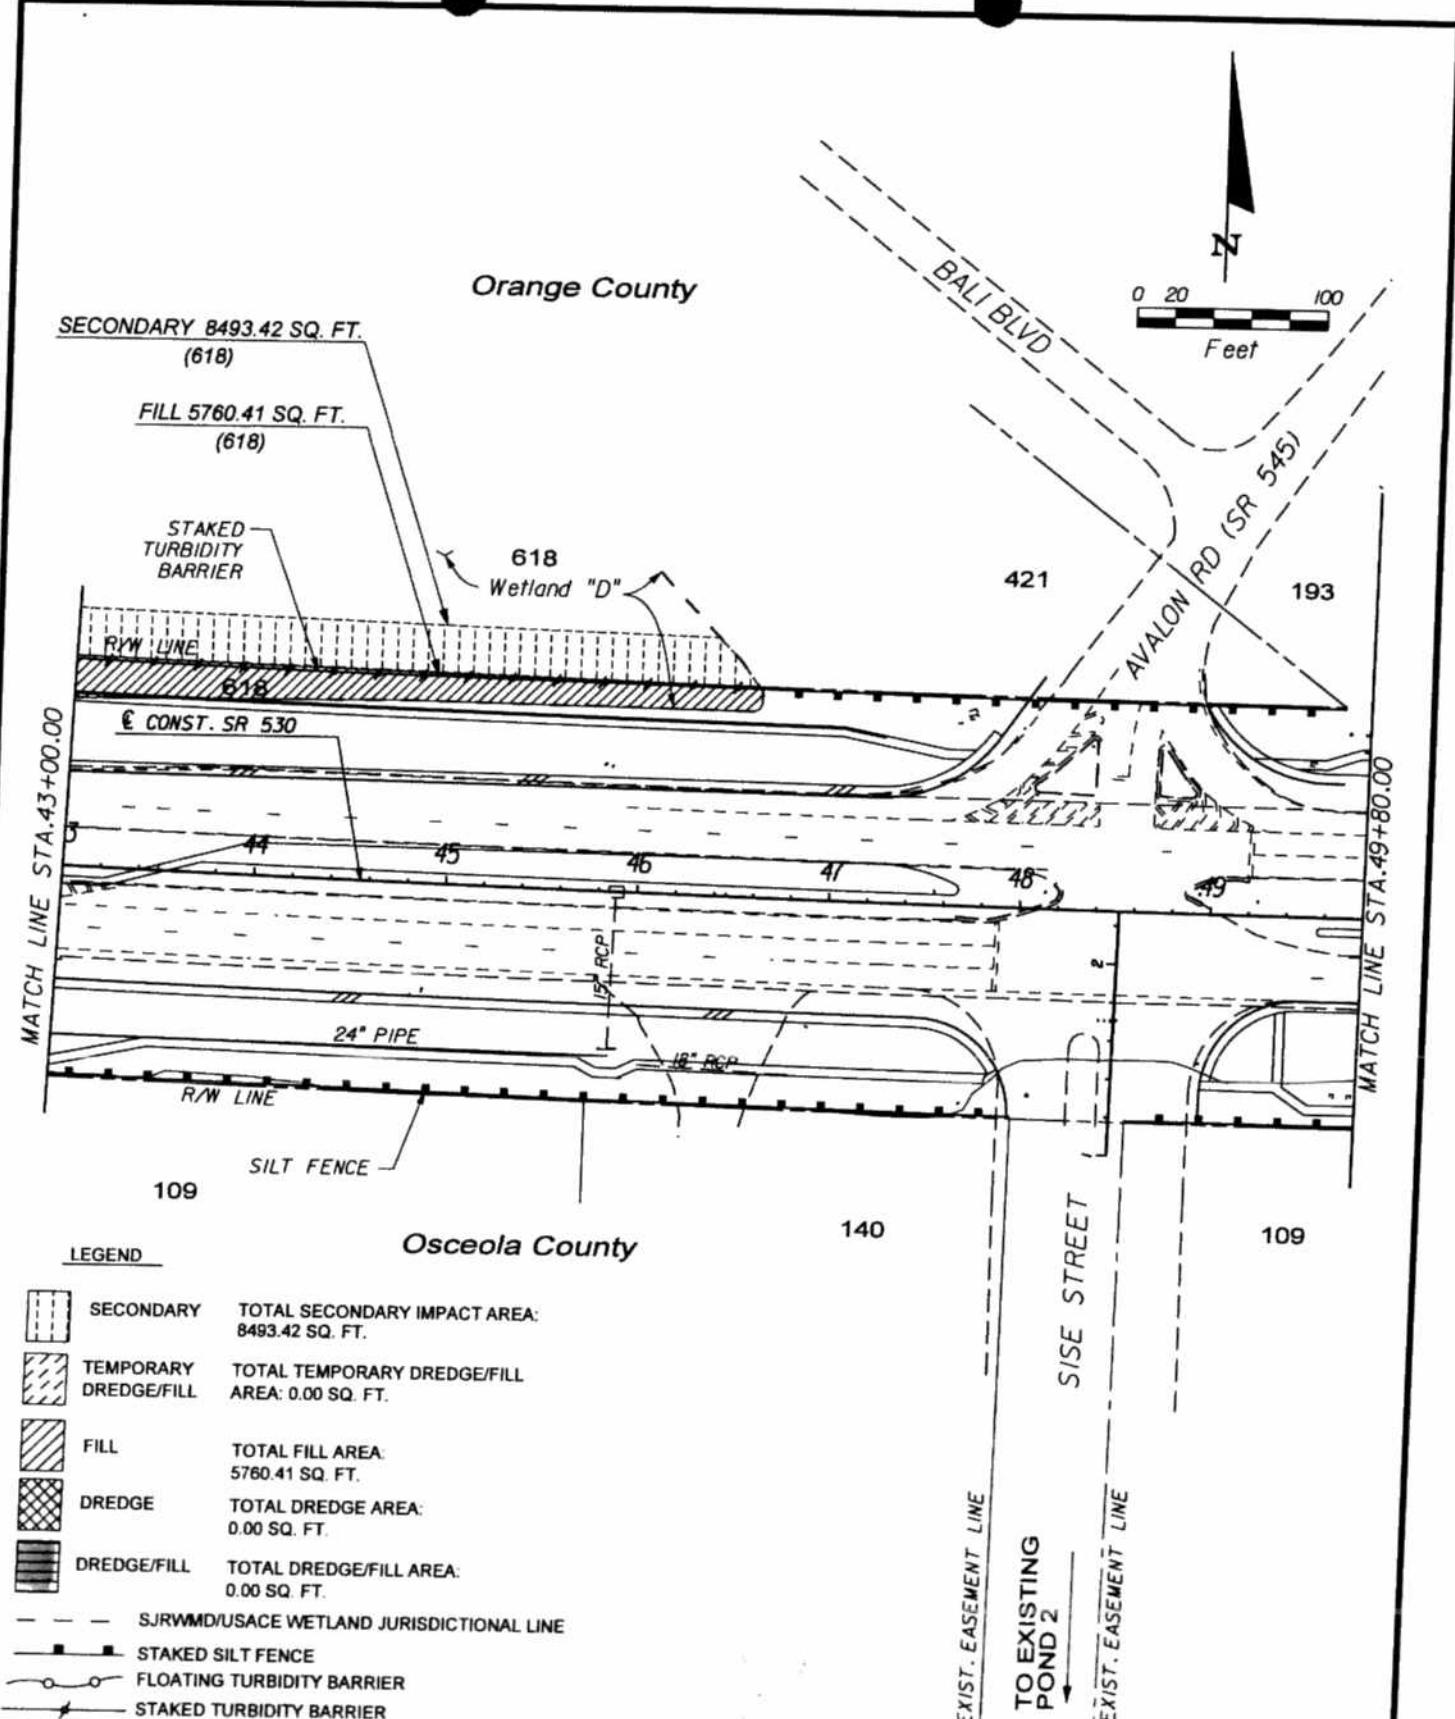

APPLICANT: FLORIDA DEPARTMENT OF TRANSPORTATION
(DISTRICT FIVE)
PROJECT: STATE ROAD NO. 530 WIDENING
LOCATION: ORANGE COUNTY OF FLORIDA
DATUM: NGVD 1929


Karen Acree Snyder
Signed: Karen Acree Snyder
P.E. NO. 47762
CH2MHILL
225 E. Robinson Street Suite 505
Orlando, FL 32801
License No. 000072

DREDGE/FILL DETAILS
PURPOSE: WETLAND IMPACTS
SECTIONS: 31, 32 T24S R27E
SECTIONS: 5, 6 T25S R27E
ORANGE-OSCEOLA COUNTY
DATE: APRIL 07, 2008
SHEET NO. 6 OF 23

Orange County

N

0 20 100
Feet

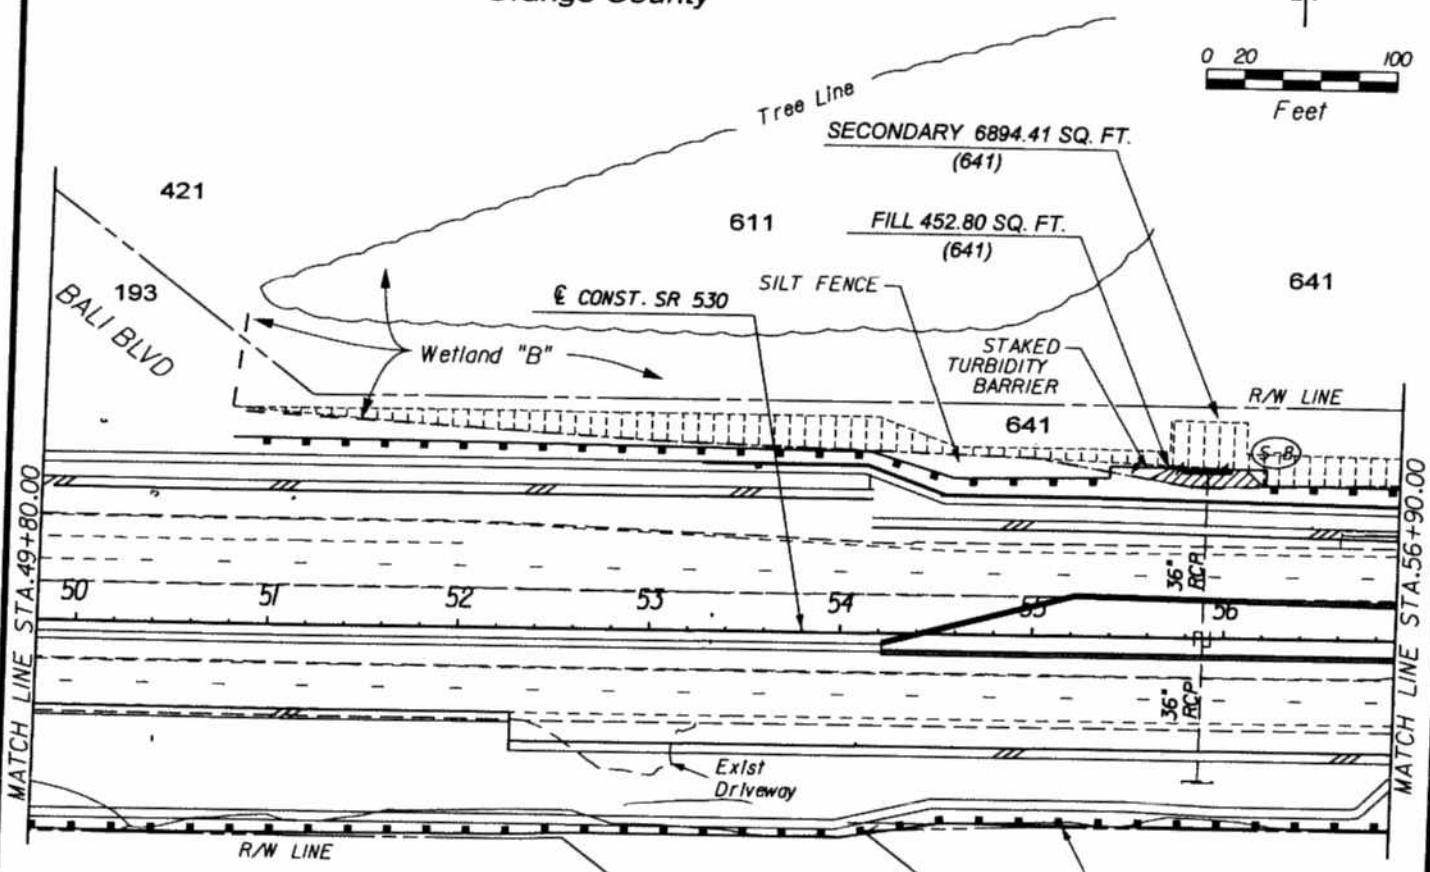

LEGEND

- SECONDARY TOTAL SECONDARY IMPACT AREA: 6894.41 SQ. FT.
- TEMPORARY DREDGE/FILL TOTAL TEMPORARY DREDGE/FILL AREA: 0.00 SQ. FT.
- FILL TOTAL FILL AREA: 452.80 SQ. FT.
- DREDGE TOTAL DREDGE AREA: 0.00 SQ. FT.
- DREDGE/FILL TOTAL DREDGE/FILL AREA: 0.00 SQ. FT.
- - - SJRWMD/USACE WETLAND JURISDICTIONAL LINE
- - - STAKED SILT FENCE
- - - FLOATING TURBIDITY BARRIER
- - - STAKED TURBIDITY BARRIER

APPLICANT: FLORIDA DEPARTMENT OF TRANSPORTATION (DISTRICT FIVE)

PROJECT: STATE ROAD NO. 530 WIDENING

LOCATION: ORANGE COUNTY OF FLORIDA

DATUM: NGVD 1929

Karen Acosta Snyder
Signed: Karen Acosta Snyder
P.E. No. 47762

CH2MHILL
225 E. Robinson Street Suite 505
Orlando, FL 32801
License No. 0000072

DREDGE/FILL DETAILS
PURPOSE: WETLAND IMPACTS
SECTIONS: 31, 32 T24S R27E
SECTIONS: 5, 6 T25S R27E
ORANGE-OSCEOLA COUNTY
DATE: APRIL 07, 2008
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#TIMES#

#FILES#


August 5, 08

Orange County

Lake Chapin

N

0 20 100
Feet

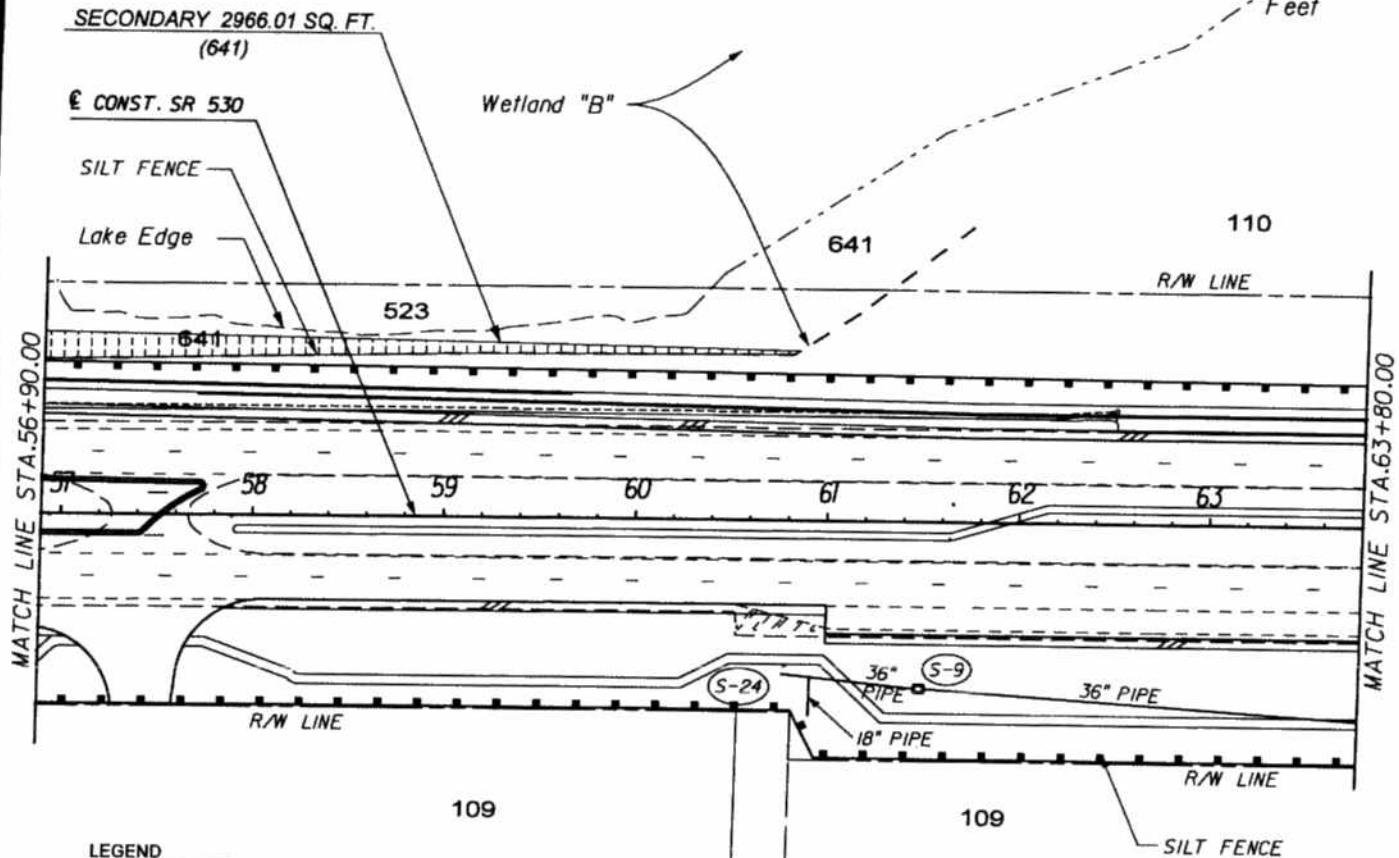

LEGEND

-  SECONDARY TOTAL SECONDARY IMPACT AREA:
2966.01 SQ. FT.
-  TEMPORARY DREDGE/FILL TOTAL TEMPORARY DREDGE/FILL AREA: 0.00 SQ. FT.
-  FILL TOTAL FILL AREA:
0.00 SQ. FT.
-  DREDGE TOTAL DREDGE AREA:
0.00 SQ. FT.
-  DREDGE/FILL TOTAL DREDGE/FILL AREA:
0.00 SQ. FT.
- — — SJRWMD/USACE WETLAND JURISDICTIONAL LINE
- ■ ■ STAKED SILT FENCE
- ○ ○ FLOATING TURBIDITY BARRIER
- ✎ ✎ STAKED TURBIDITY BARRIER

Osceola County

EXIST EASEMENT LINE
EXIST EASEMENT LINE

APPLICANT: FLORIDA DEPARTMENT OF TRANSPORTATION
(DISTRICT FIVE)

PROJECT: STATE ROAD NO. 530 WIDENING

LOCATION: ORANGE COUNTY OF FLORIDA

DATUM: NGVD 1929

Karen Snyder
Signed: Karen A. Snyder
P.E. No. 47762

CH2MHILL
225 E. Robinson Street Suite 505
Orlando, FL 32801
License No. 000072

DREDGE/FILL DETAILS
PURPOSE: WETLAND IMPACTS
SECTIONS: 31, 32 T24S R27E
SECTIONS: 5, 6 T25S R27E
ORANGE - OSCEOLA COUNTY
DATE: APRIL 07, 2008
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August 5, 08

Lake Chapin

523

Orange County

110

E CONST. SR 530

SILT FENCE

R/W LINE

MATCH LINE STA. 63+80.00

R/W LINE

140

LEGEND



SECONDARY TOTAL SECONDARY IMPACT AREA: 6927.93 SQ. FT.



TEMPORARY TOTAL TEMPORARY DREDGE/FILL AREA: 0.00 SQ. FT.



FILL TOTAL FILL AREA: 9847.00 SQ. FT.



DREDGE TOTAL DREDGE AREA: 0.00 SQ. FT.



DREDGE/FILL TOTAL DREDGE/FILL AREA: 0.00 SQ. FT.

SJRWMD/USACE WETLAND JURISDICTIONAL LINE

STAKED SILT FENCE

FLOATING TURBIDITY BARRIER

STAKED TURBIDITY BARRIER

APPLICANT: FLORIDA DEPARTMENT OF TRANSPORTATION
(DISTRICT FIVE)

PROJECT: STATE ROAD NO. 530 WIDENING

LOCATION: ORANGE COUNTY OF FLORIDA

DATUM: NGVD 1929

Karen A. Snyder

Signed: Karen A. Snyder

P.E. NO. 47762

CH2MHILL

225 E. Robinson Street Suite 505
Orlando, FL 32801
License No. 000072

Wetland "A"
Lake Apache
524

641

421

R/W LINE

0 20 100
Feet

ARRENA RD

POND 5

641
Fence Type B
Index No 802

SILT FENCE

113.0

108.25

86.0

O-B3

S-13

641

421

36" PIPE

64

65

36" PIPE

66

36" PIPE

67

36" PIPE

68

36" PIPE

69

36" PIPE

70

36" PIPE

814

618

618

618

641

R/W LINE

SILT FENCE

193

STAKED

TURBIDITY

BARRIER

LEGACY BLVD

FILL 9847.00 SQ. FT.

(618)

SECONDARY 6927.93 SQ. FT.

(618)

Osceola County

DREDGE/FILL DETAILS

PURPOSE: WETLAND IMPACTS

SECTIONS: 31, 32 T24S R27E

SECTIONS: 5, 6 T25S R27E

ORANGE-OSCEOLA COUNTY

DATE: APRIL 07, 2008


SHEET NO. 9 OF 23

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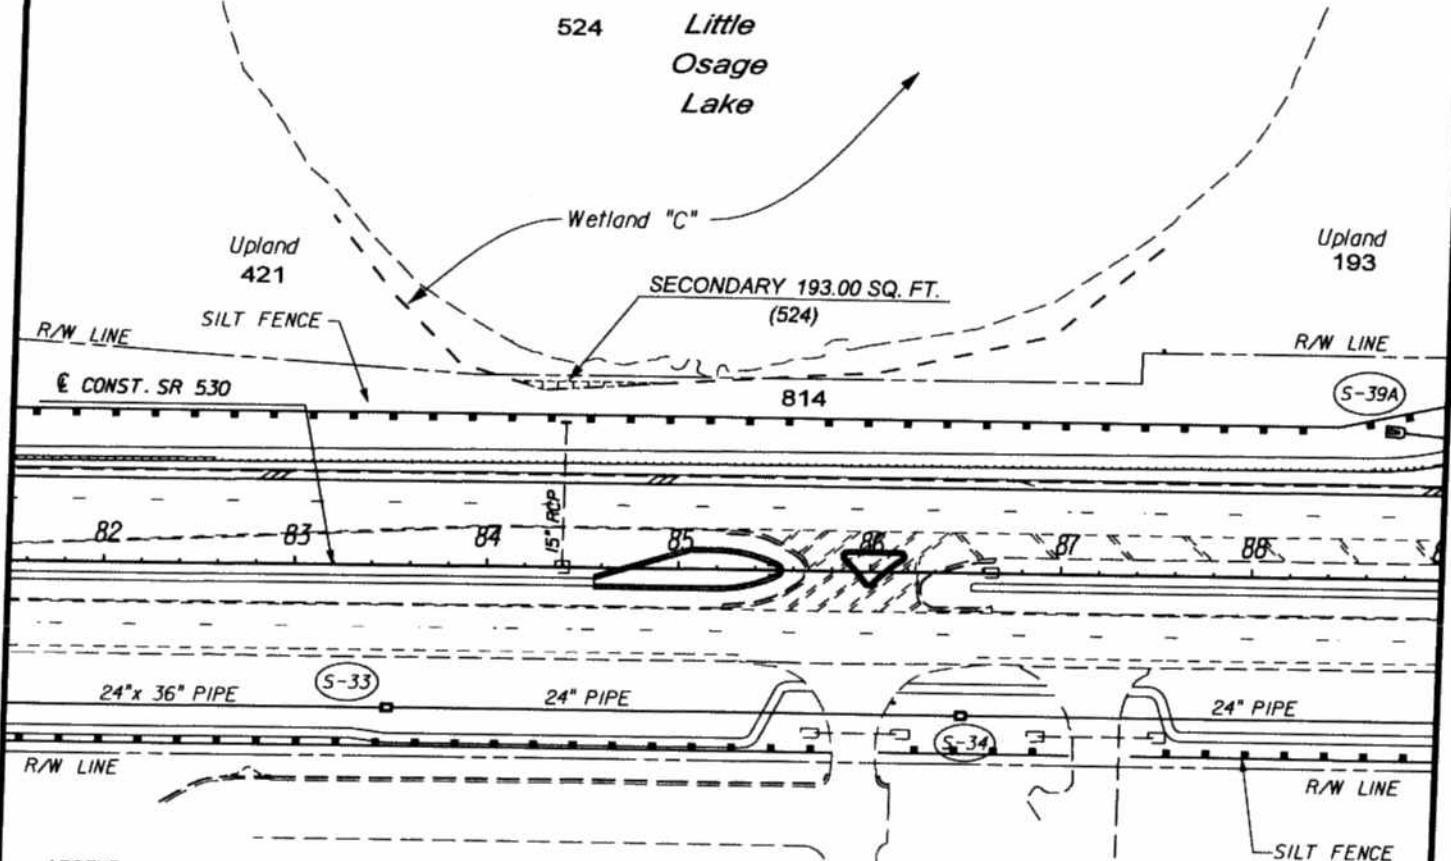
August 5, 08



Orange County

N

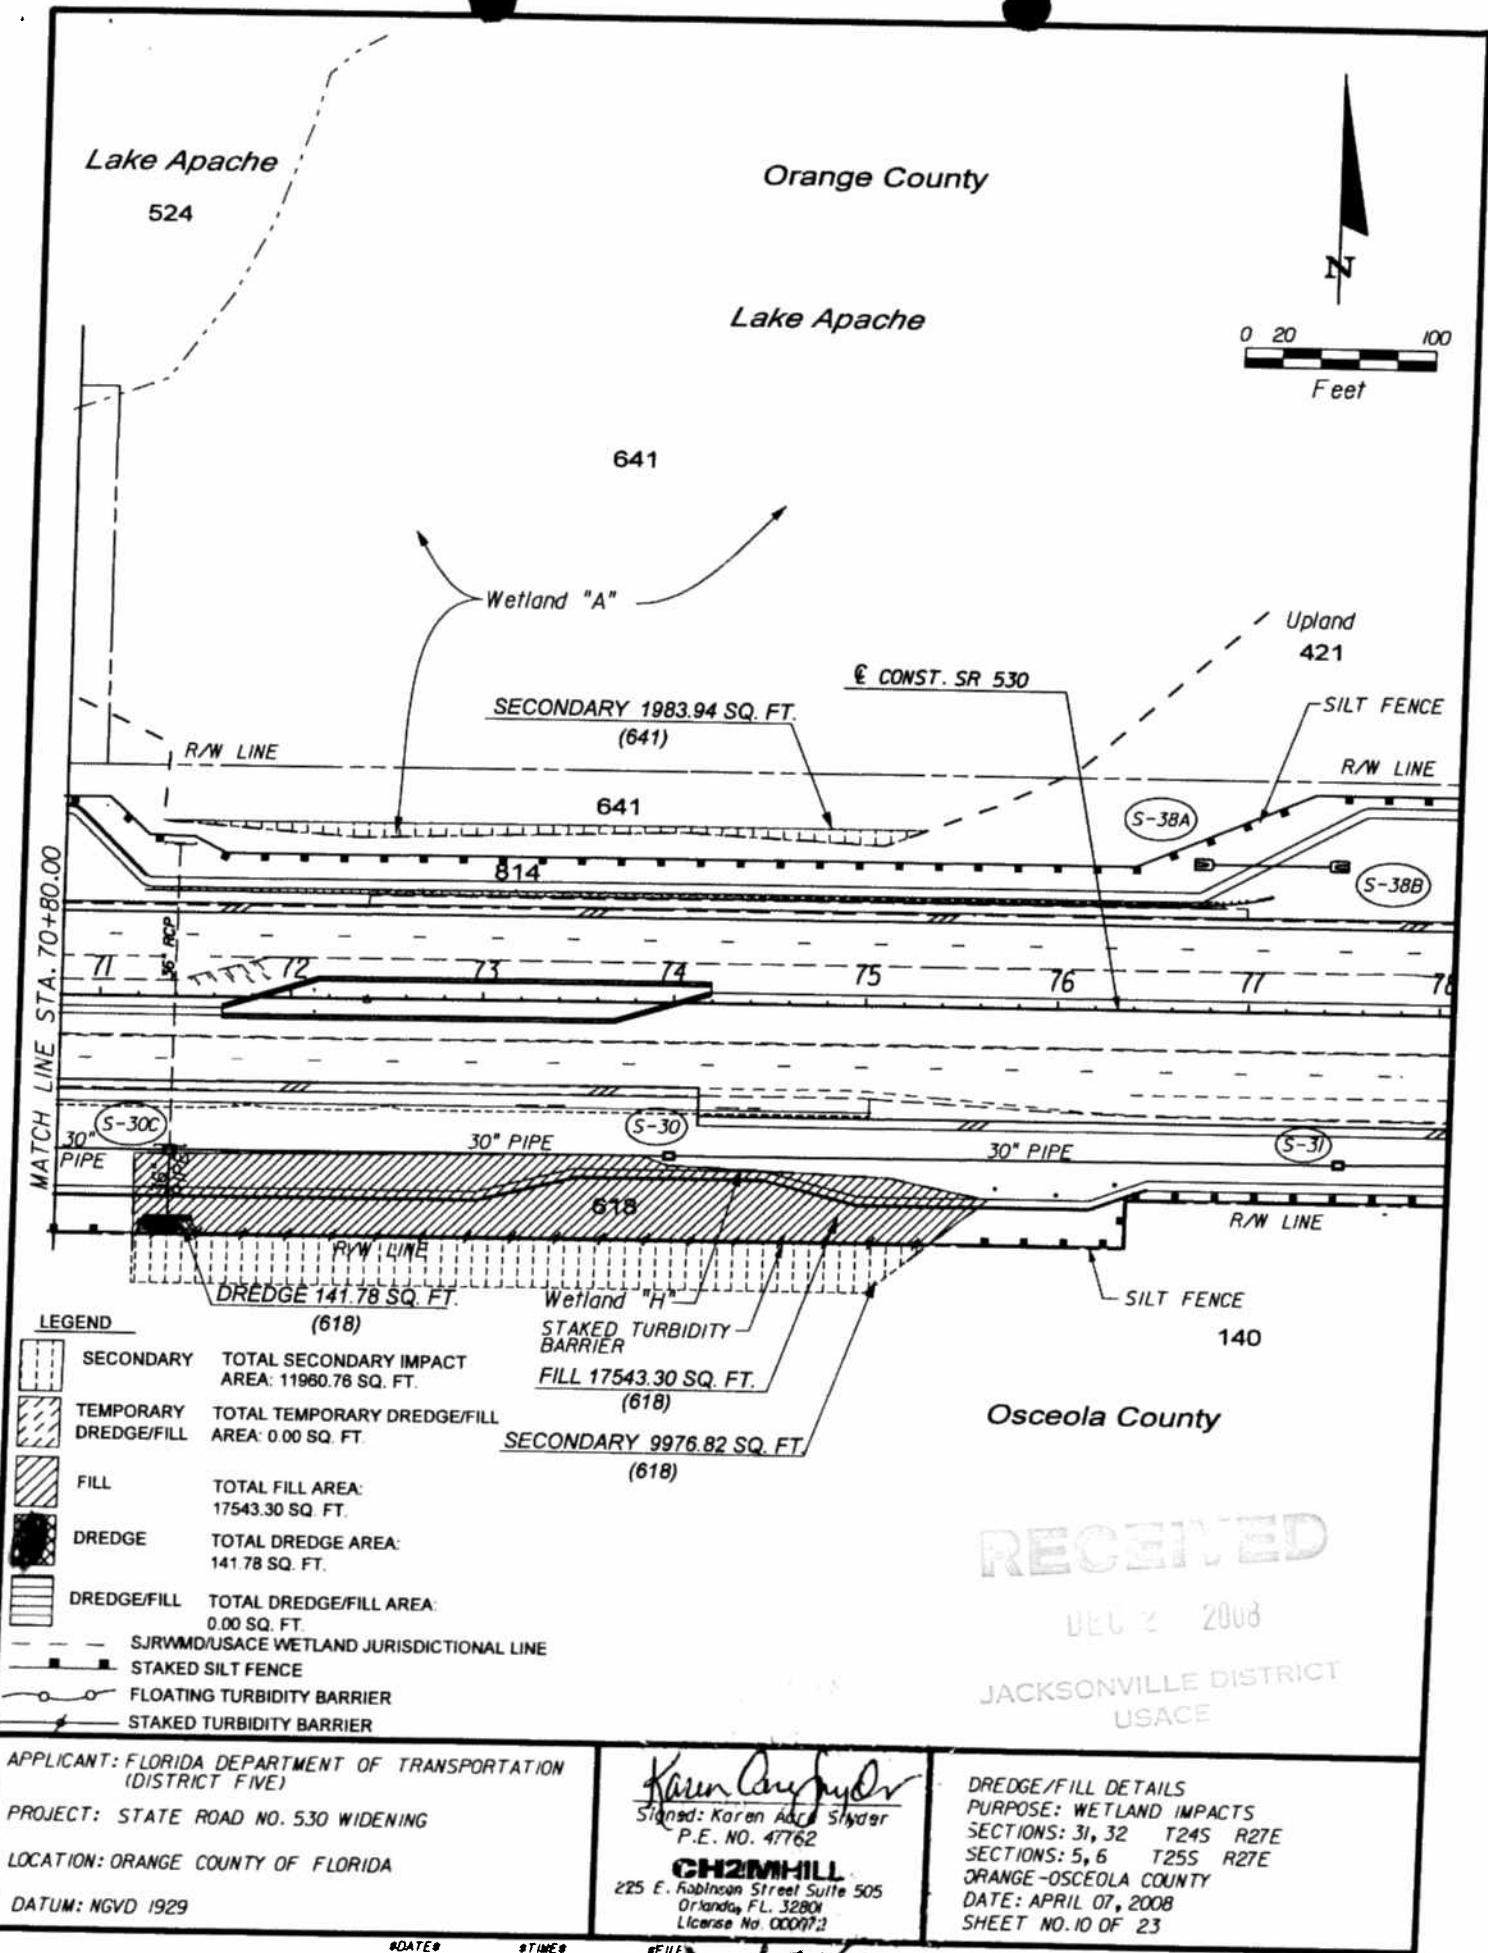0 20 100
Feet



LEGEND

	SECONDARY	TOTAL SECONDARY IMPACT AREA: 193.00 SQ. FT.
	TEMPORARY DREDGE/FILL	TOTAL TEMPORARY DREDGE/FILL AREA: 0.00 SQ. FT.
	FILL	TOTAL FILL AREA: 0.00 SQ. FT.
	DREDGE	TOTAL DREDGE AREA: 0.00 SQ. FT.
	DREDGE/FILL	TOTAL DREDGE/FILL AREA: 0.00 SQ. FT.
- - -	SJRWM/USACE WETLAND JURISDICTIONAL LINE	
—	STAKED SILT FENCE	
—○—	FLOATING TURBIDITY BARRIER	
→	STAKED TURBIDITY BARRIER	

Osceola County

APPLICANT: FLORIDA DEPARTMENT OF TRANSPORTATION
(DISTRICT FIVE)

PROJECT: STATE ROAD NO. 530 WIDENING

LOCATION: ORANGE COUNTY OF FLORIDA

DATUM: NGVD 1929

Signed: Karen Acre Snyder
P.E. NO. 47762

CH2MHILL
225 E. Robinson Street Suite 505
Orlando, FL 32801
License No. 000072


DREDGE/FILL DETAILS
PURPOSE: WETLAND IMPACTS
SECTIONS: 31, 32 T24S R27E
SECTIONS: 5, 6 T25S R27E
ORANGE-OSCEOLA COUNTY
DATE: APRIL 07, 2008
SHEET NO. 11 OF 23

BOATED


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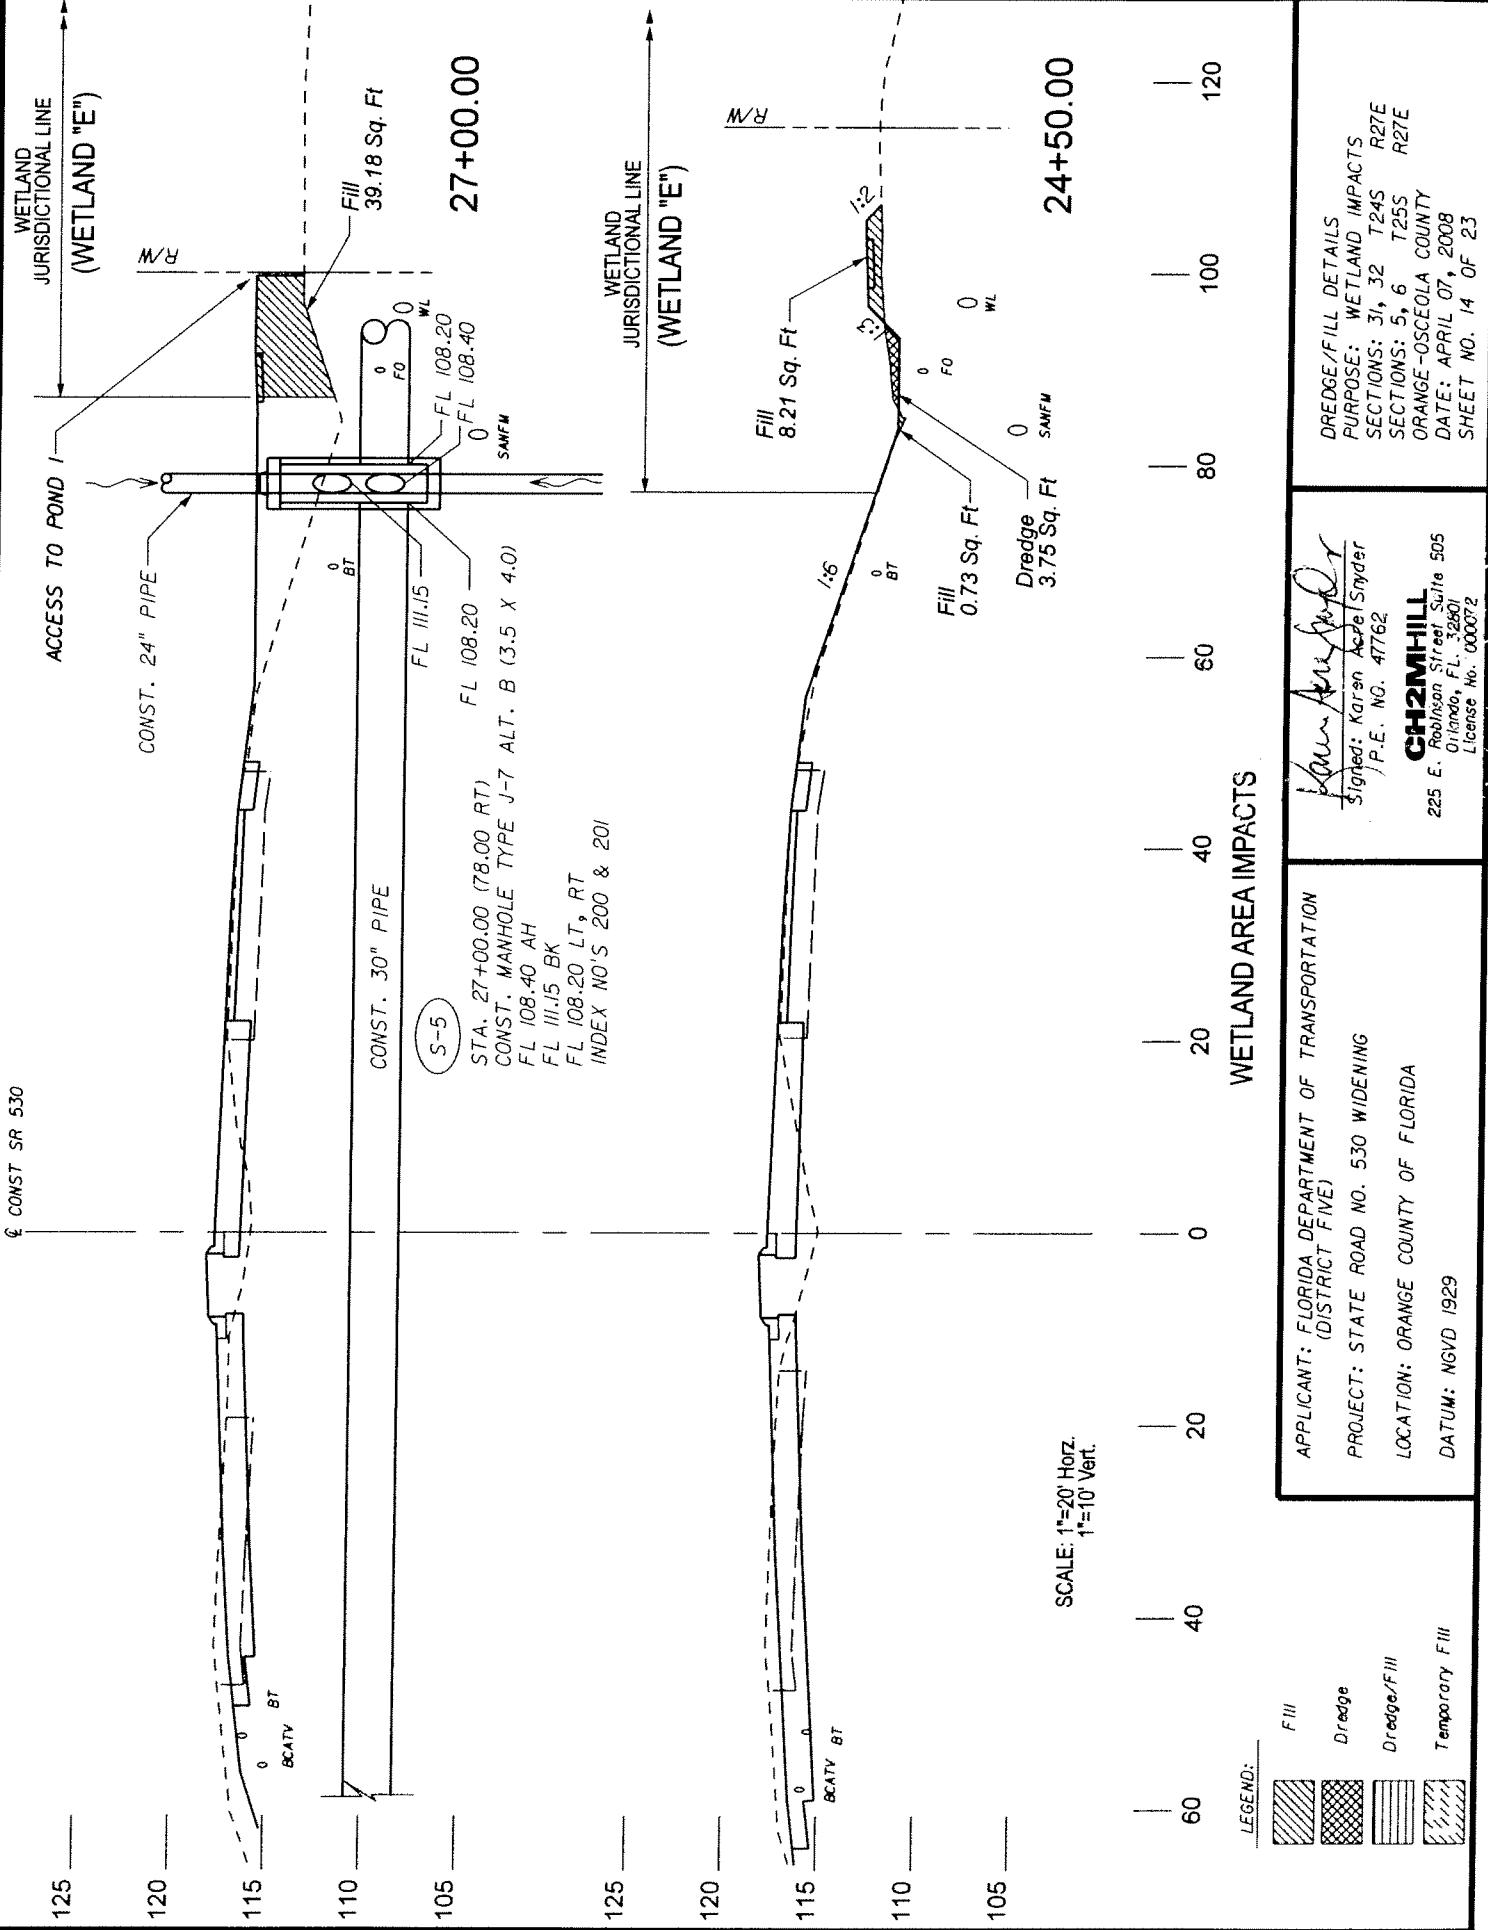
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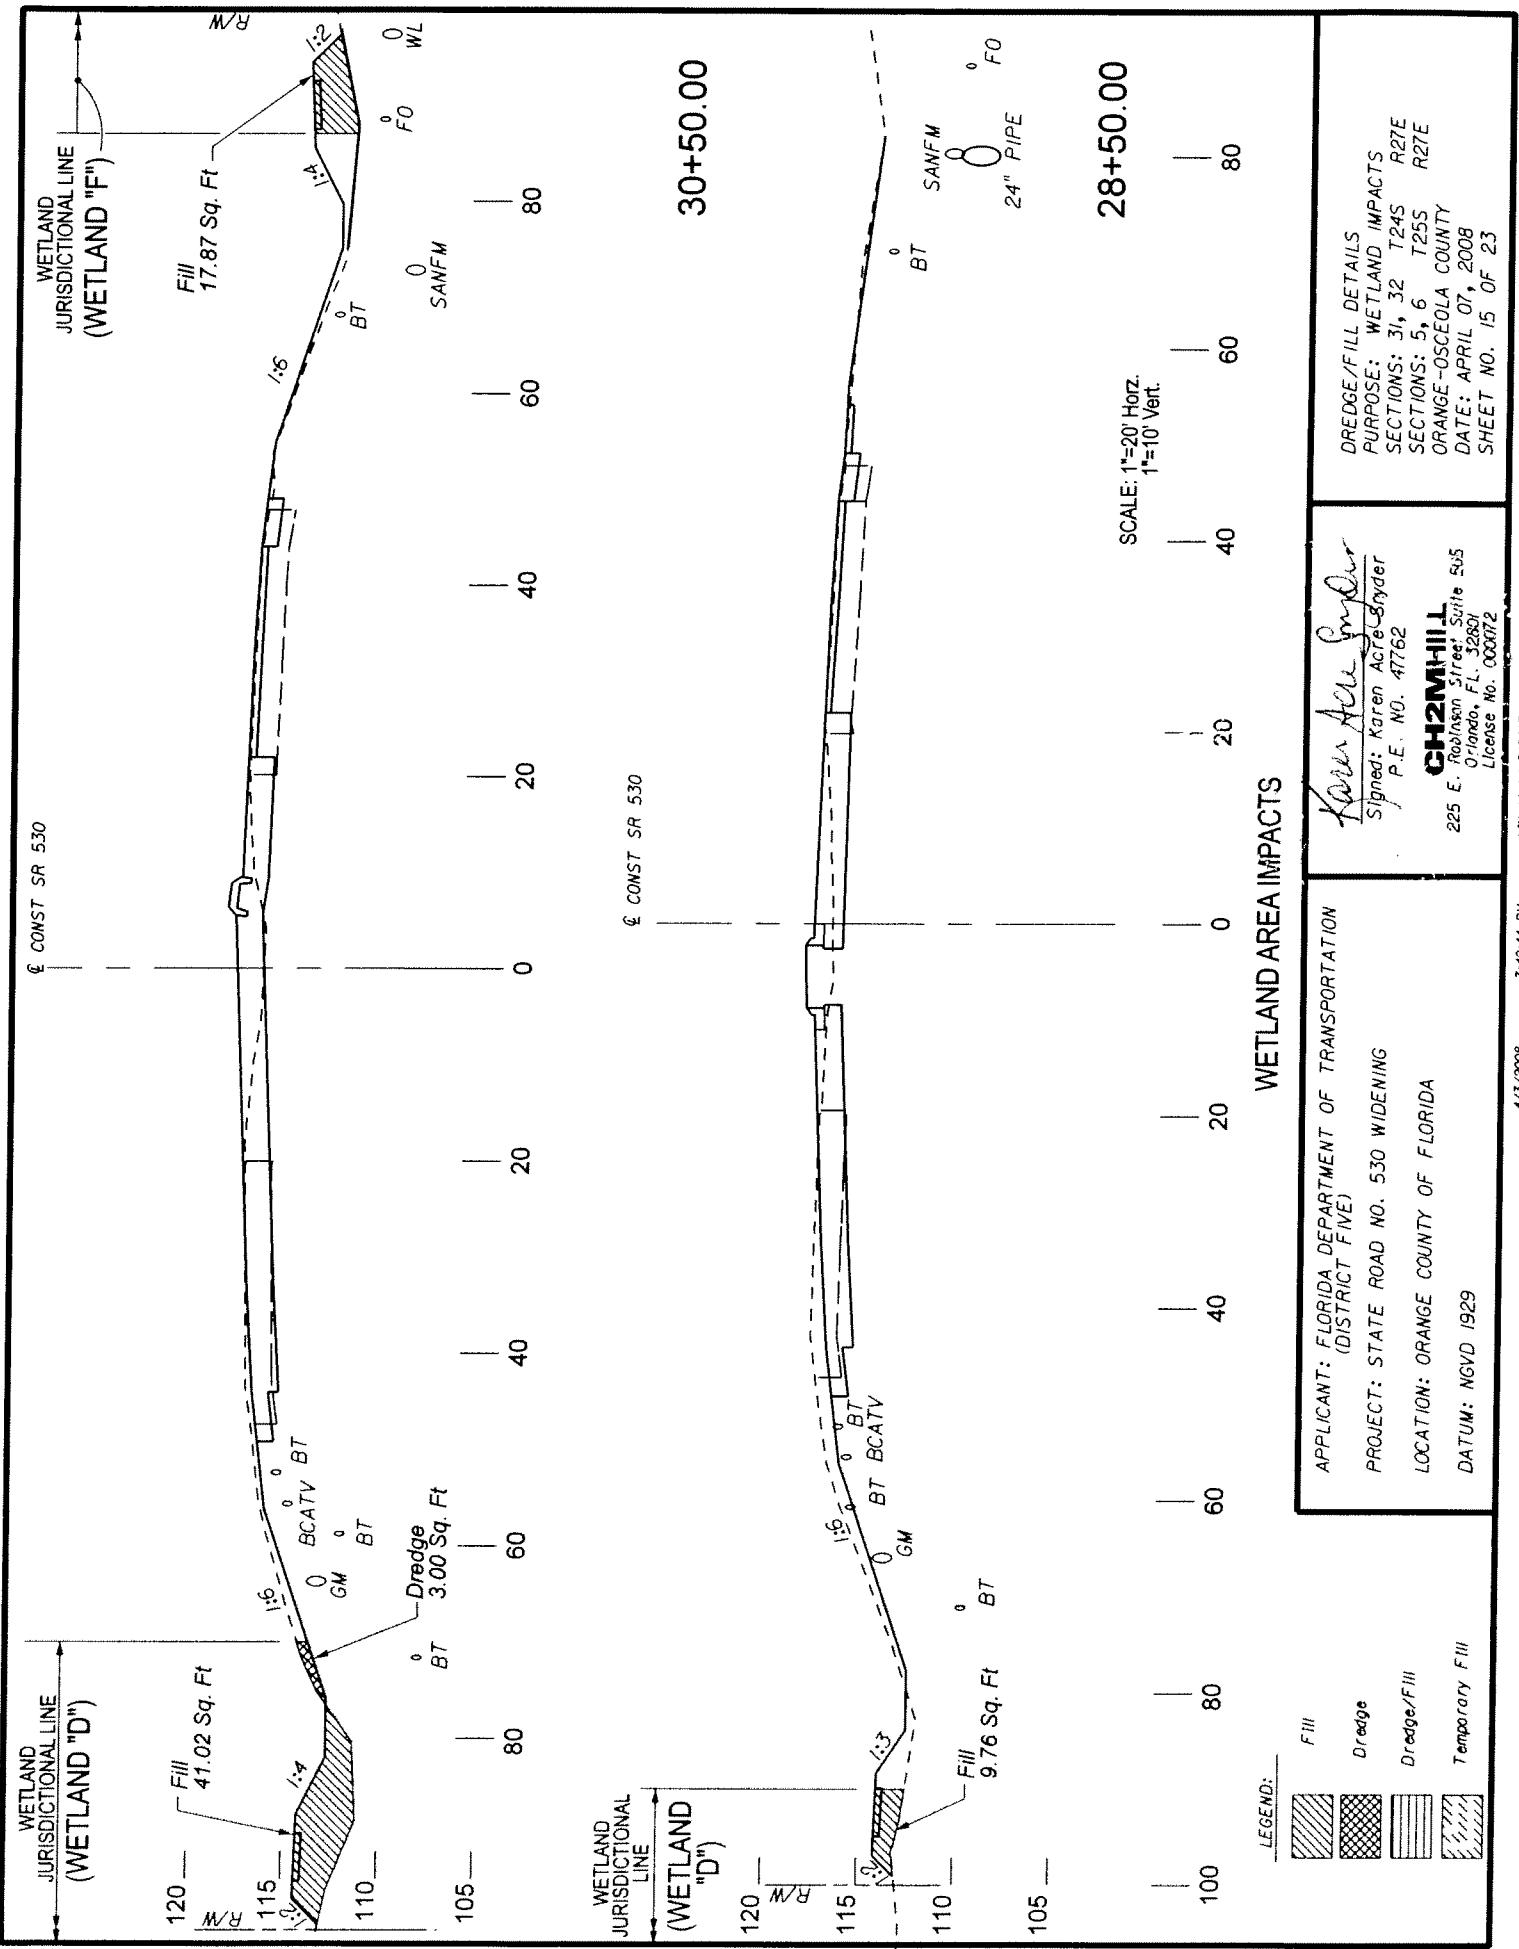
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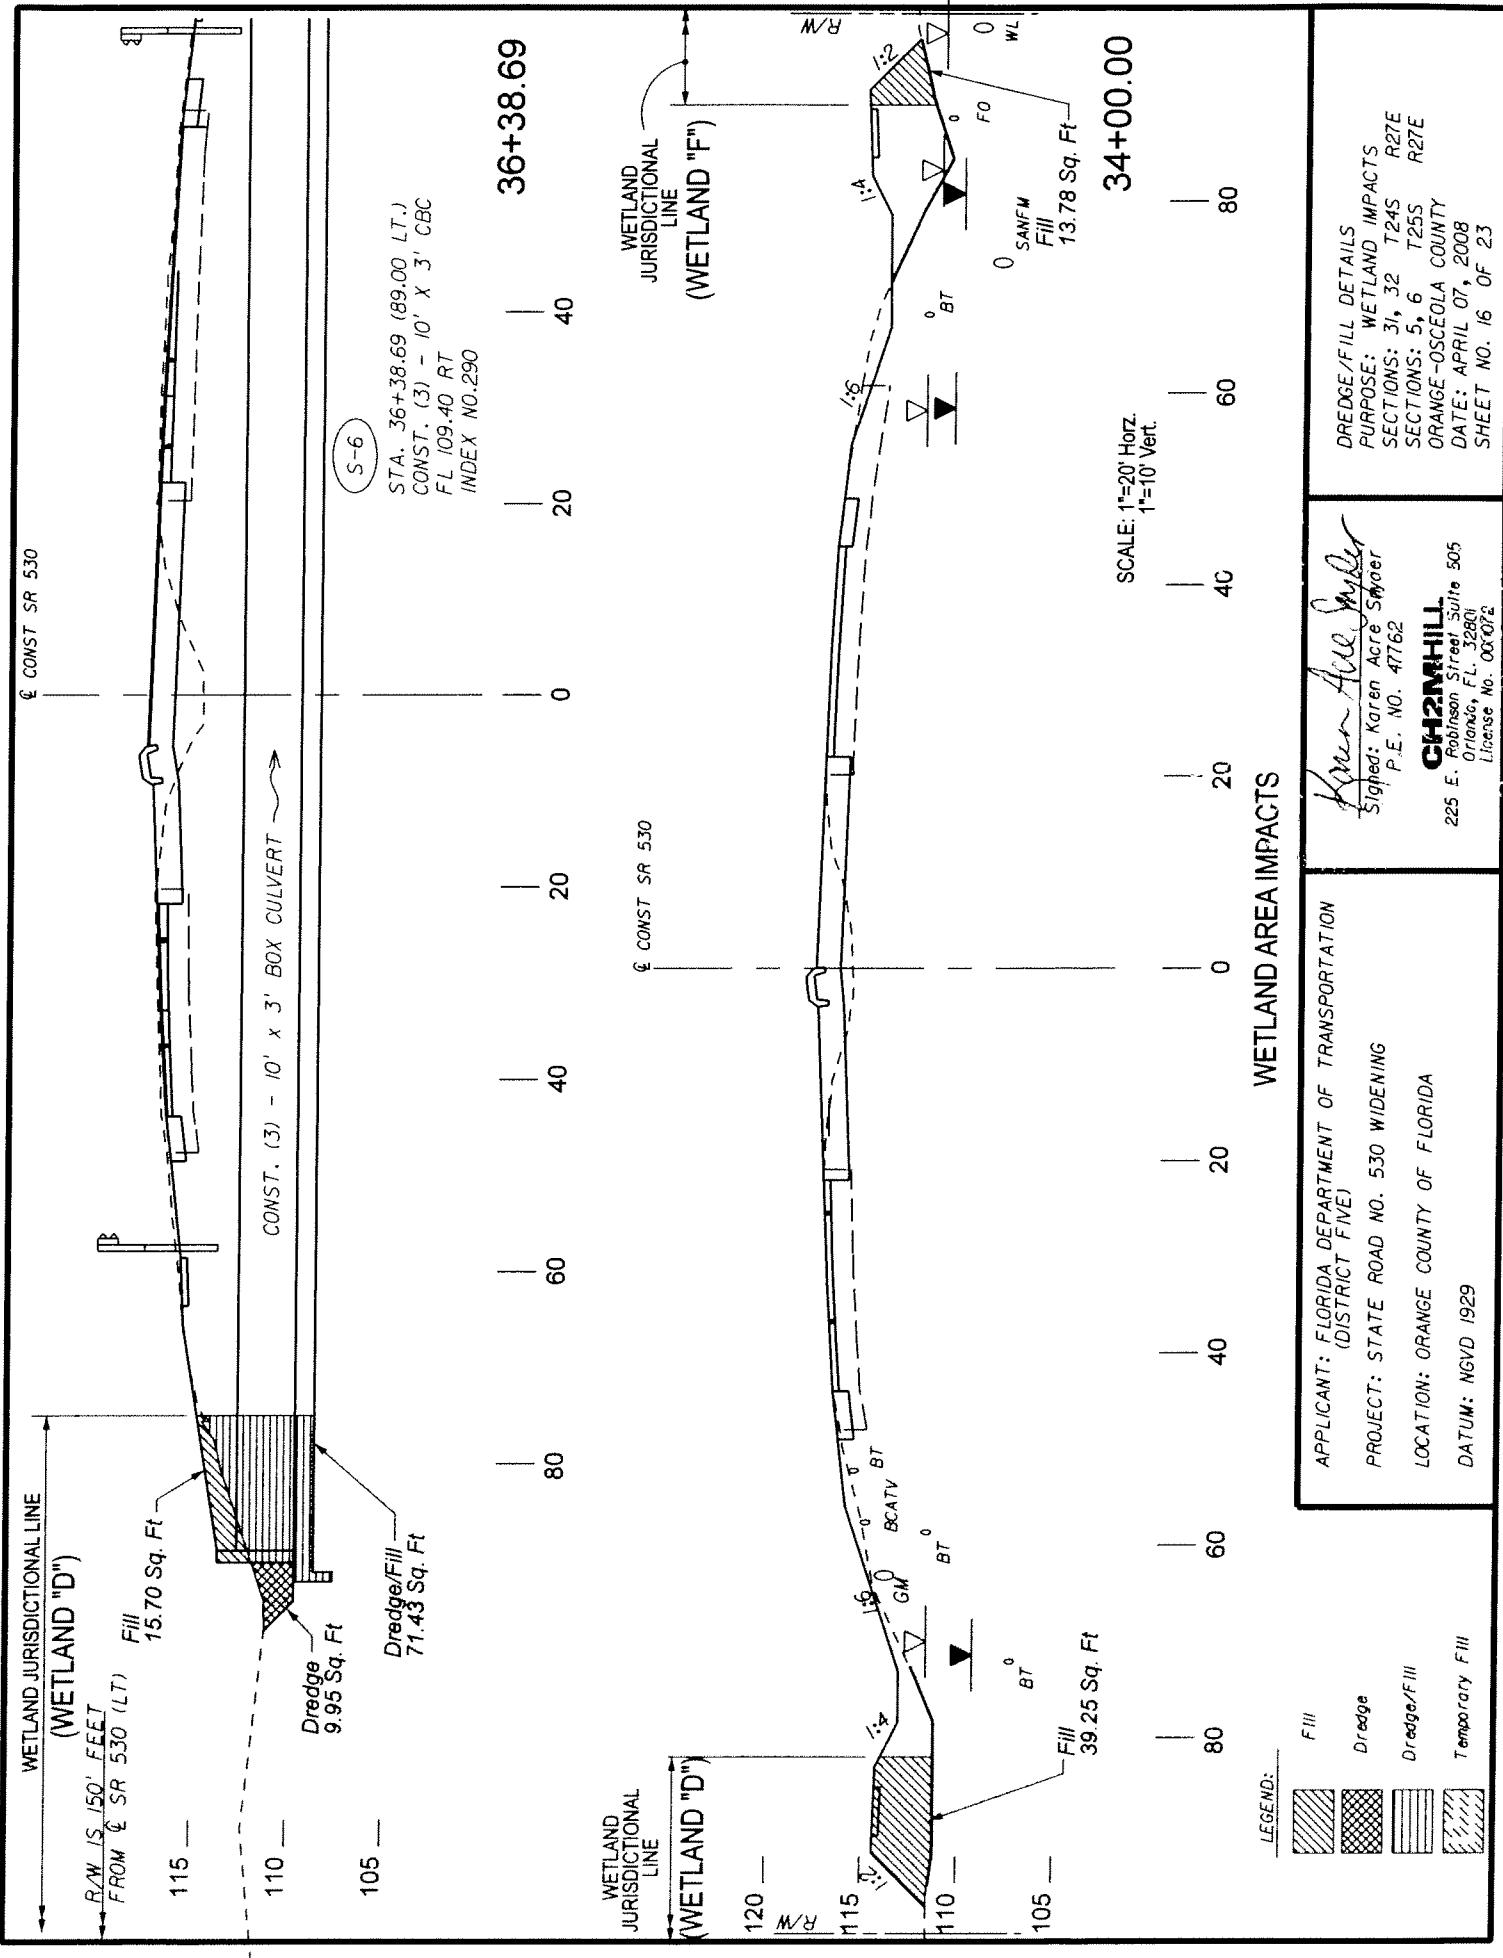



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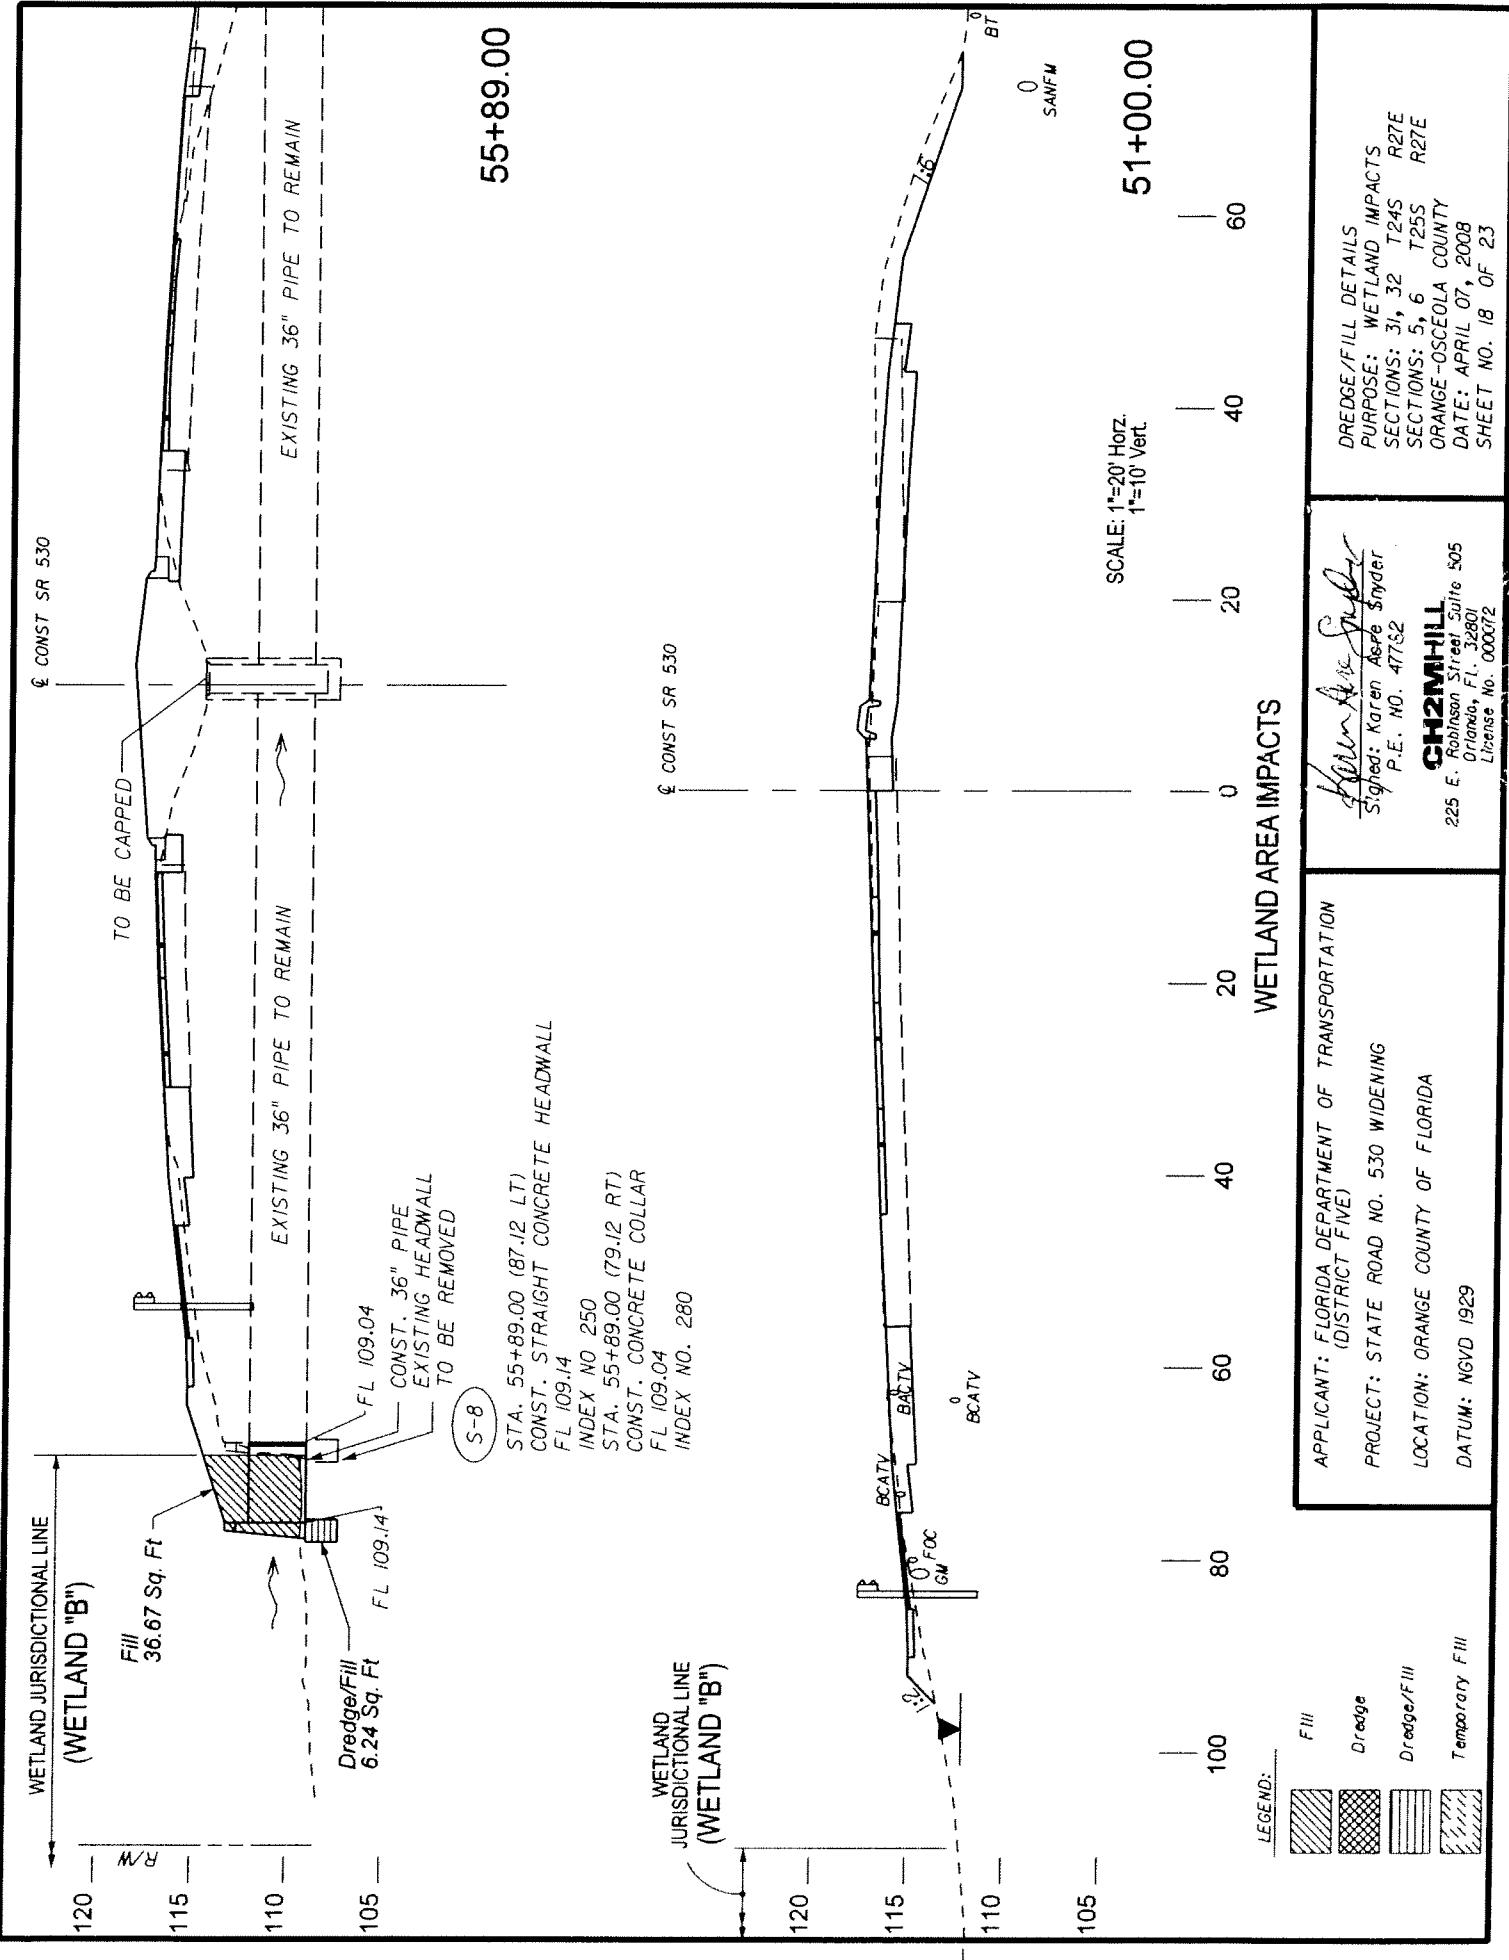




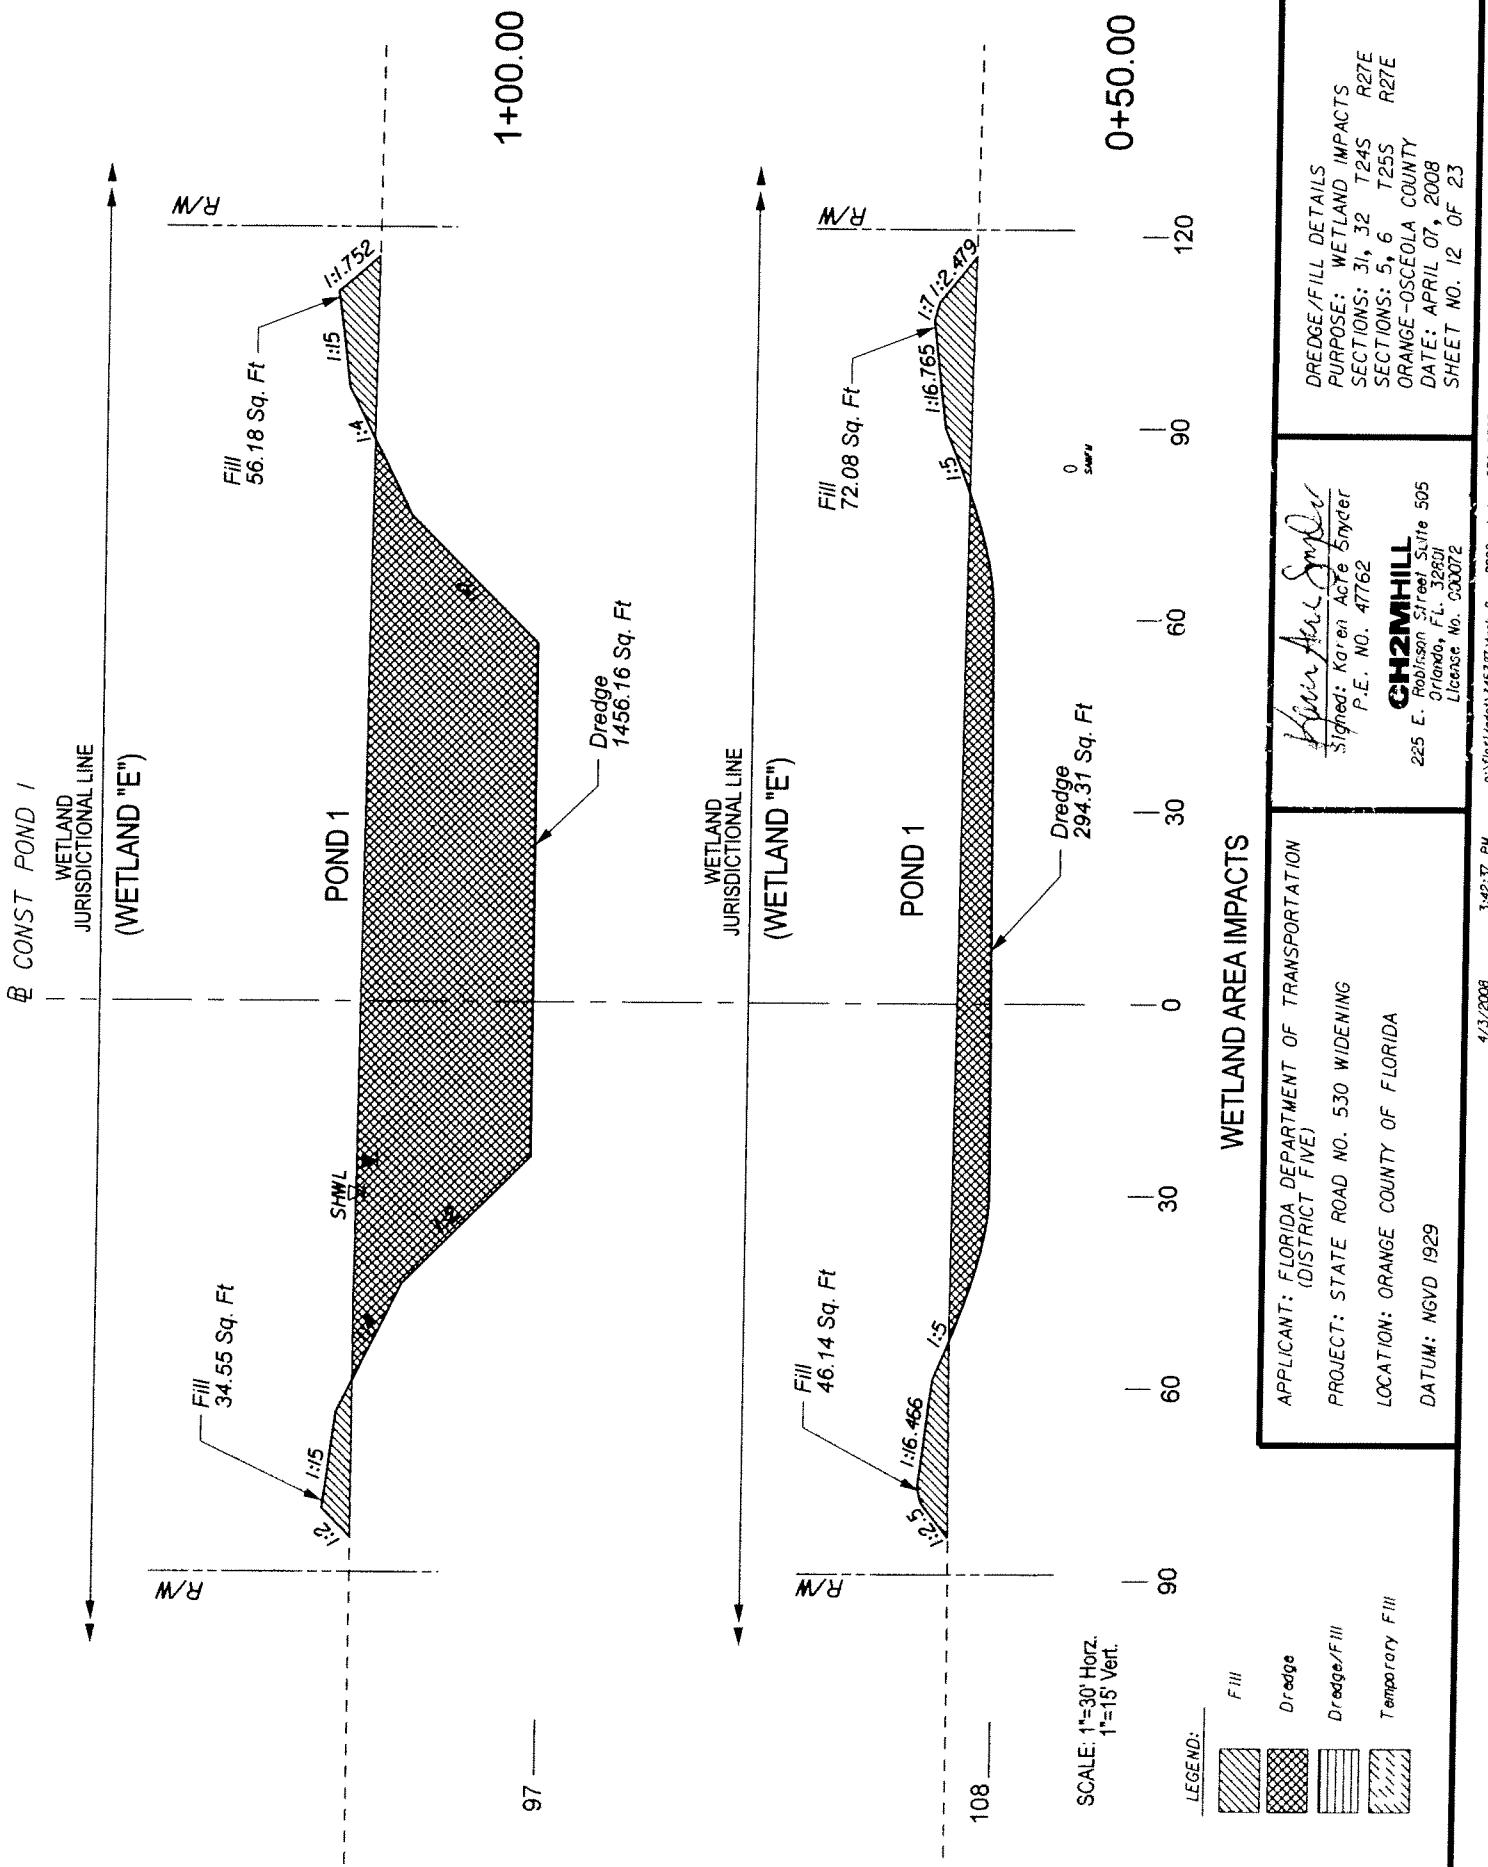




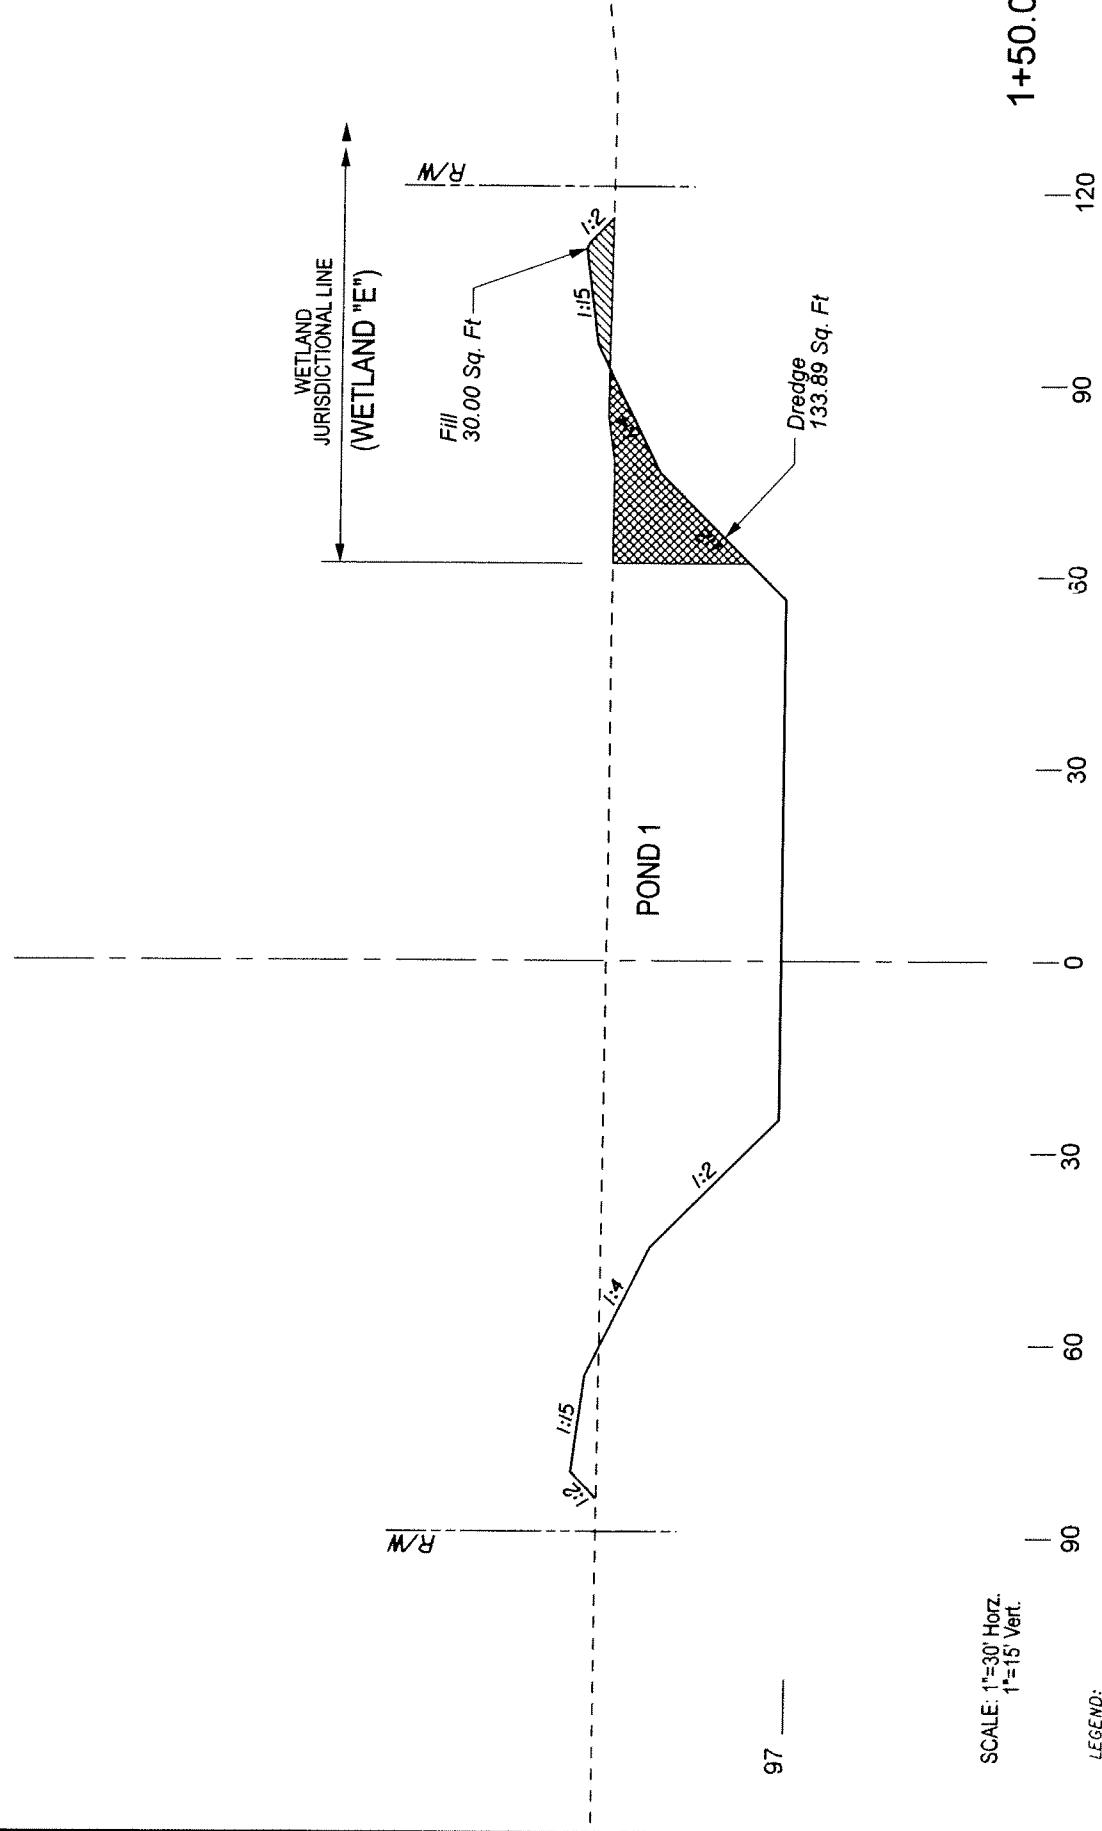

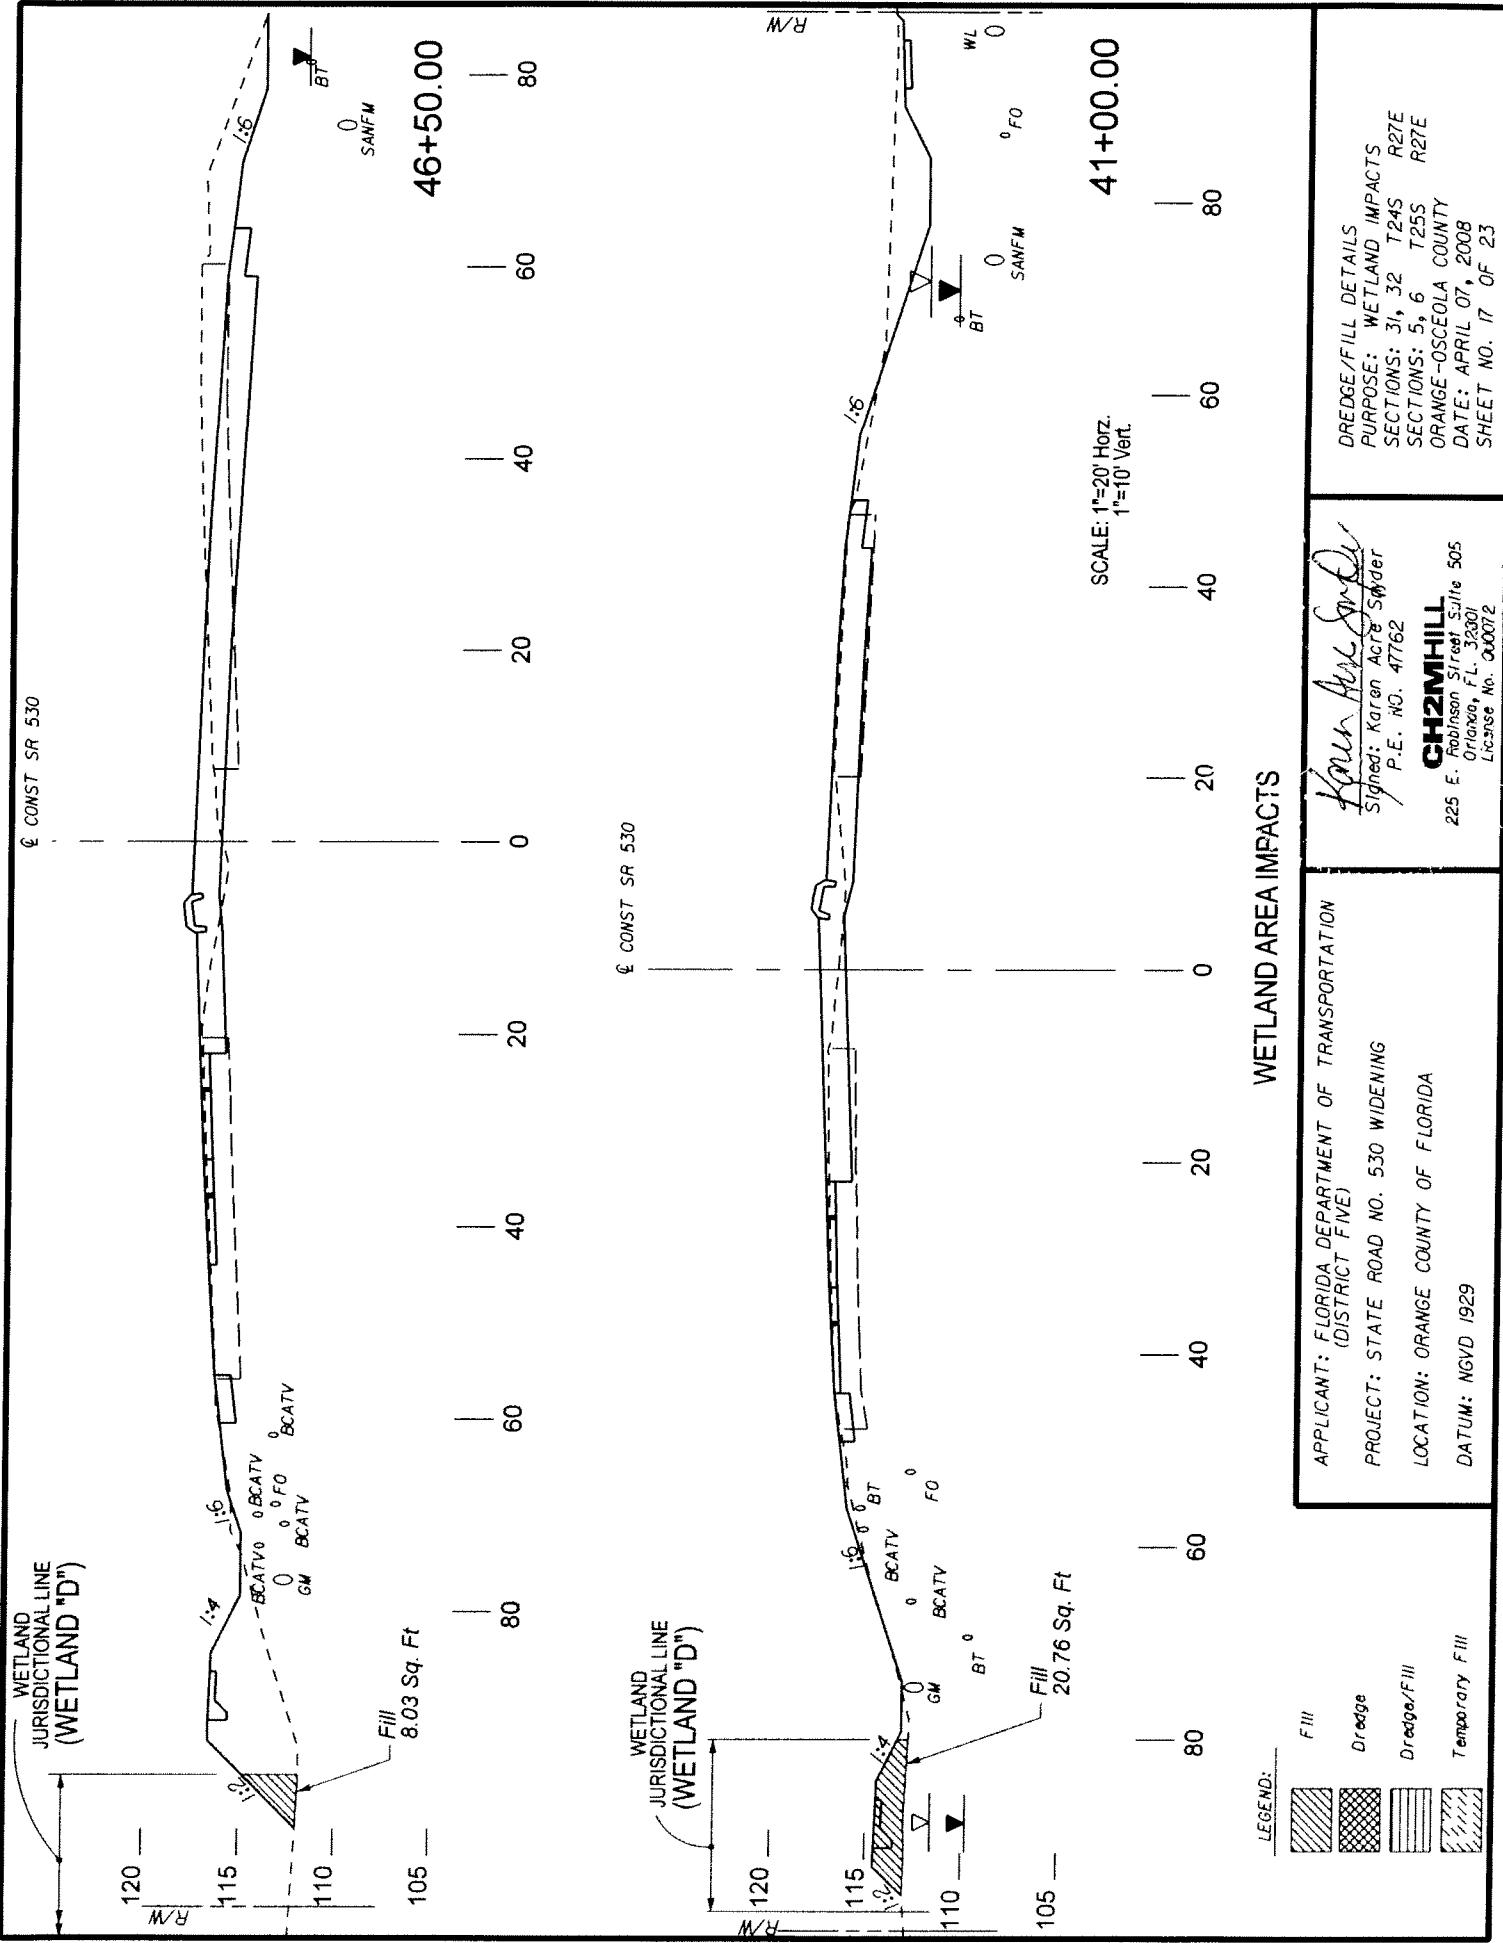


WETLAND JURISDICTIONAL LINE
(WETLAND "B")

R/W
120 —
115 —
110 —
105 —

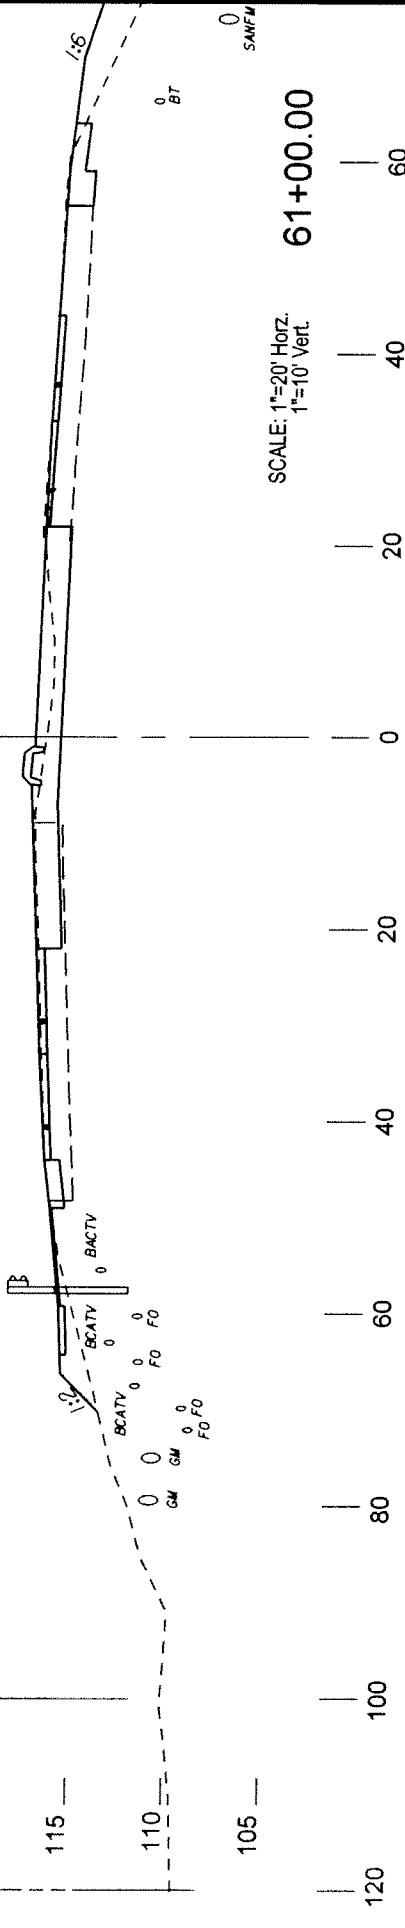

LEGEND:

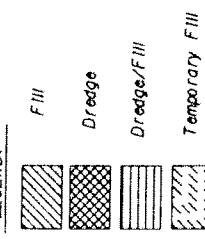

WETLAND AREA IMPACTS

APPLICANT: FLORIDA DEPARTMENT OF TRANSPORTATION (DISTRICT FIVE)	DREDGE/FILL DETAILS
PROJECT: STATE ROAD NO. 530 WIDENING	PURPOSE: WETLAND IMPACTS
LOCATION: ORANGE COUNTY OF FLORIDA	SECTIONS: 31, 32 T24S R27E
DATUM: NGVD 1929	SECTIONS: 5, 6 T25S R27E

CH2MHILL	ORANGE -OSCEOLA COUNTY
225 E. Robinson Street Suite 505 Orlando, FL 32801 License No. 000012	DATE: APRIL 07, 2008
	SHEET NO. 19 OF 23

SCALE: 1"=20' Horz.
1"=10' Vert.


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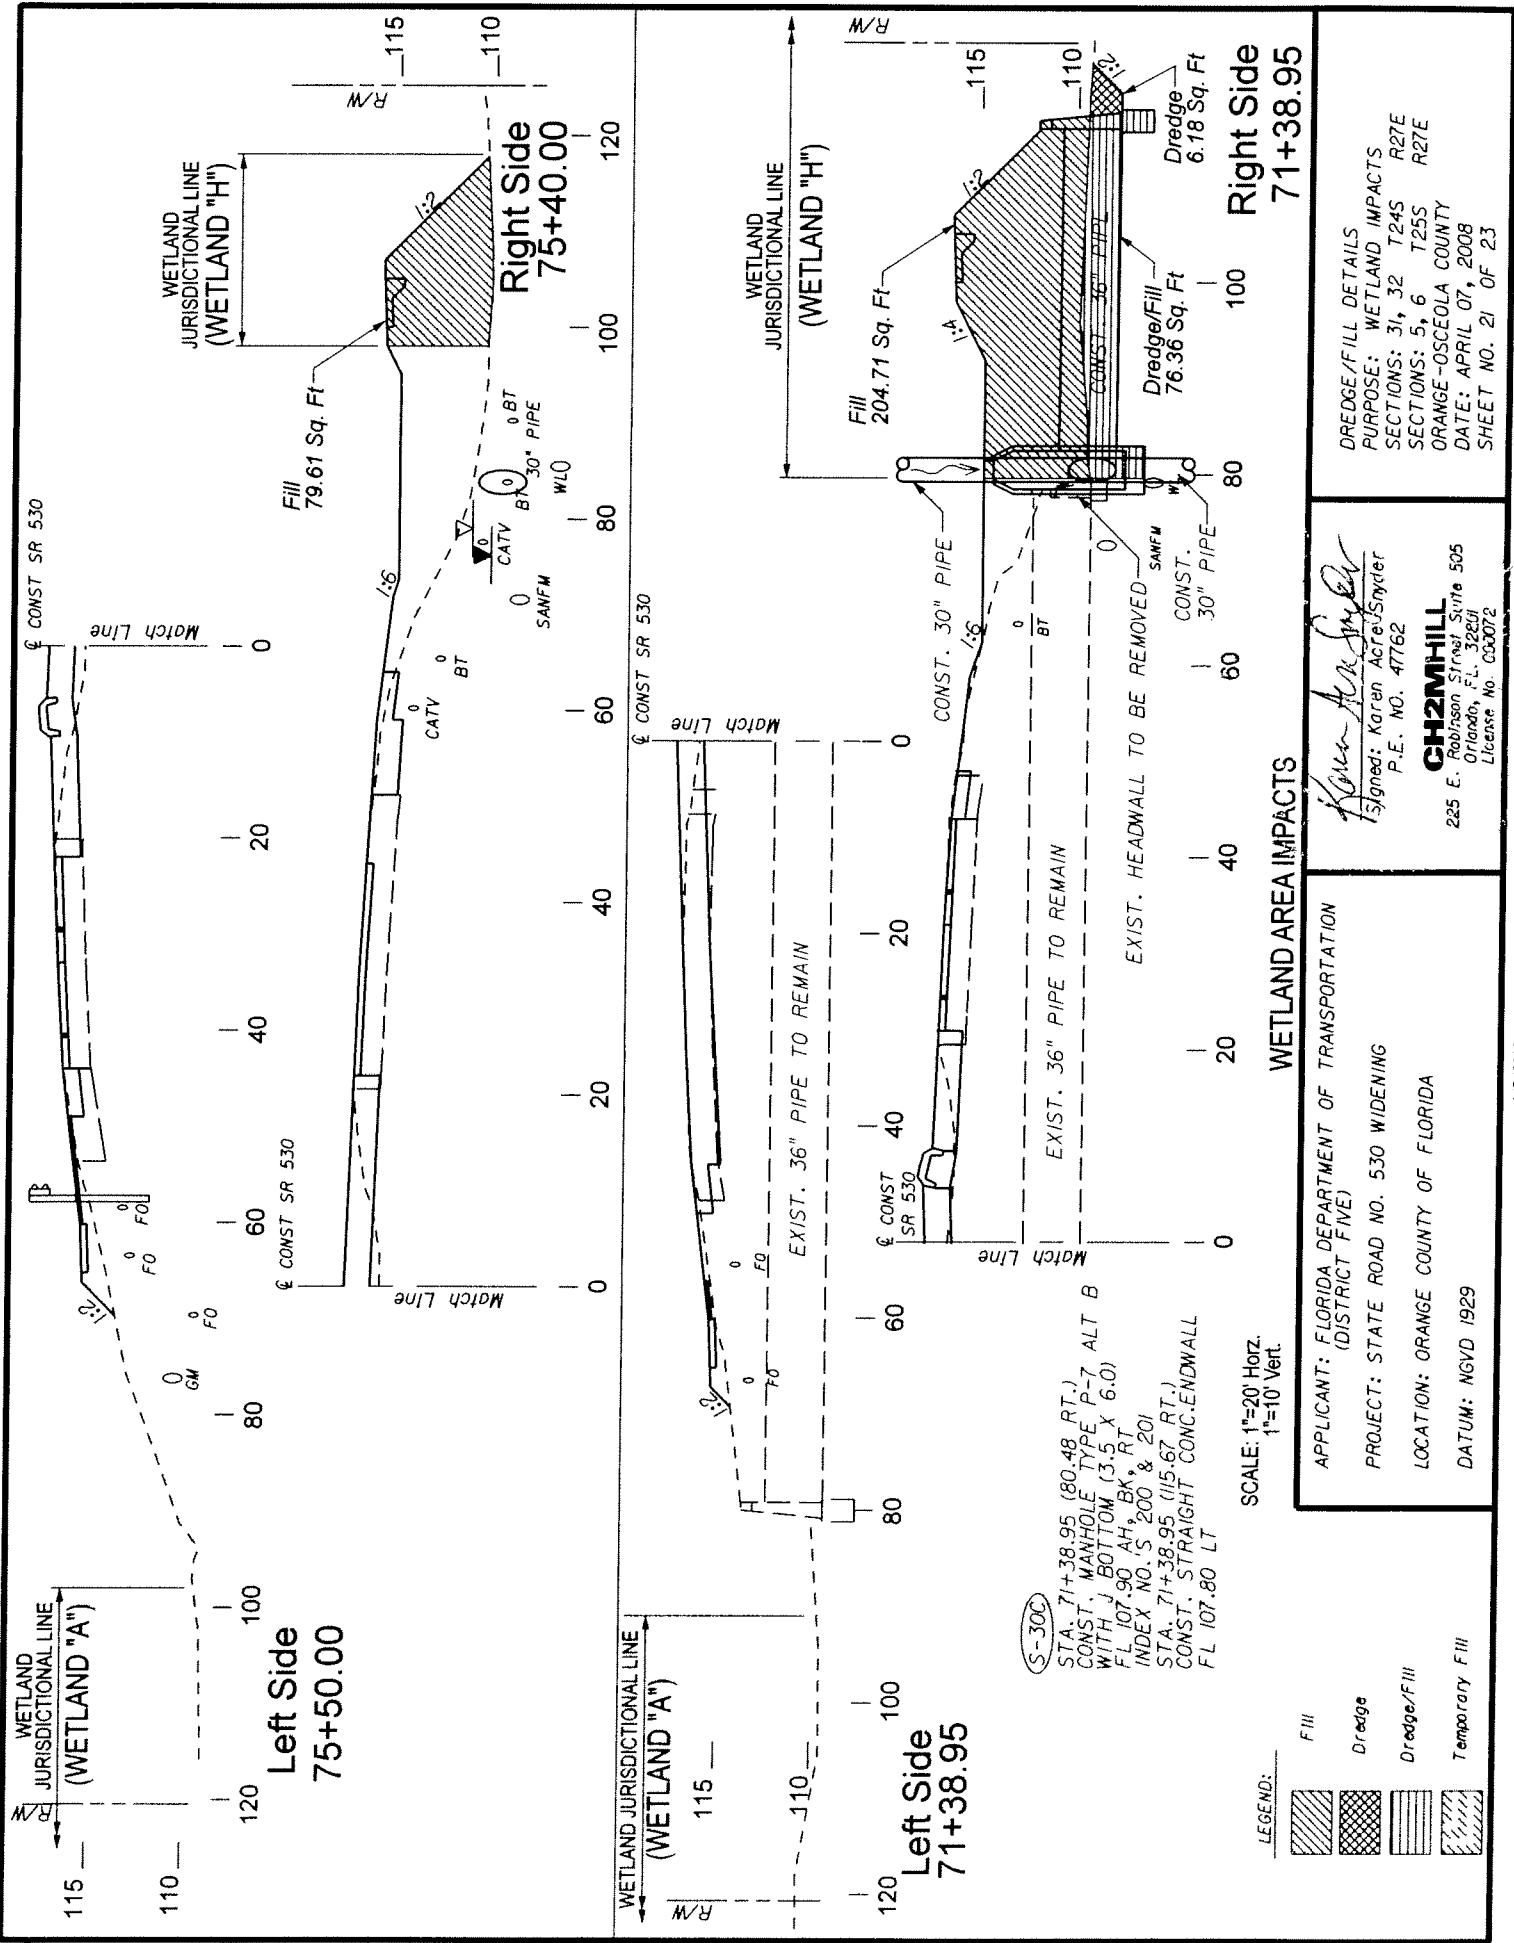
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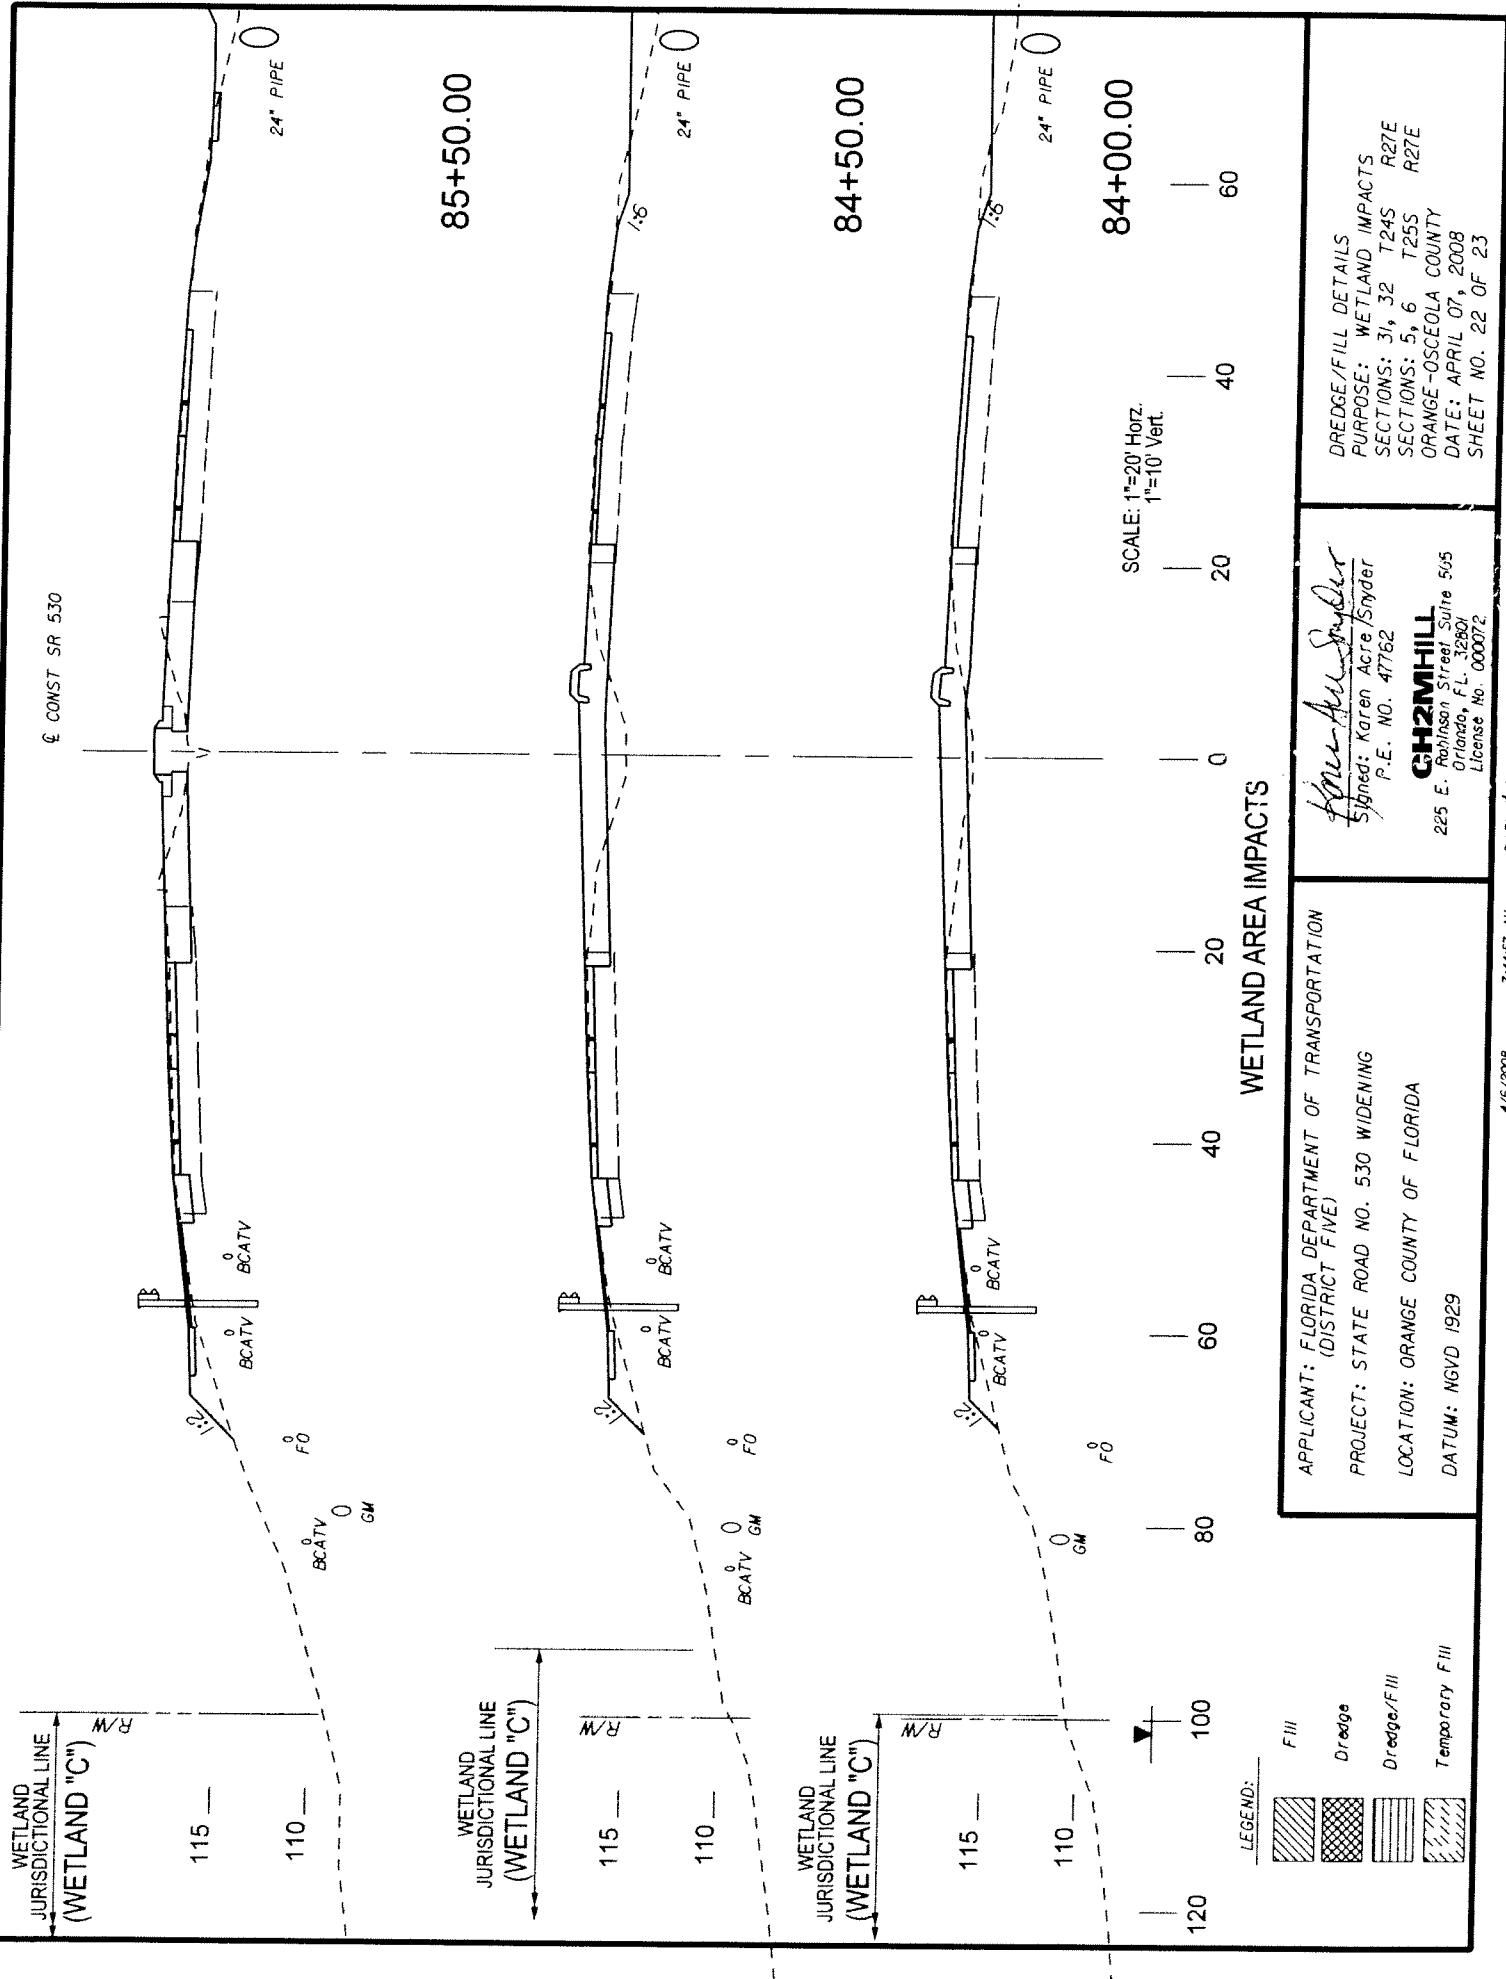
DREDGE/FILL DETAILS
PURPOSE: WETLAND IMPACTS
SECTIONS: 31, 32 T24S R27E
SECTIONS: 5, 6 T25S R27E
ORANGE -OSCEOLA COUNTY
DATE: APRIL 07, 2008
SHEET NO. 19 OF 23

Karen Acre Smidler
Signed: Karen Acre Smidler
P.E. No. 47762

Permitting #4558788-8 - 2008 m/sr 530 239304-1 permitting.vroomayypermits3.dgn
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JURISDICTIONAL WETLAND IMPACTS SUMMARY TABLE

WETLAND ID	FLUCFCS Codes					IMPACTED VOLUME-CU. YD. (AC-FT)		
		FILL	DREDGE	DREDGE/FILL	TEMPORARY	FILL	DREDGE	DREDGE/FILL
Area 'A'	641	0.00 SQ.FT. (0.00 AC.)	0.00 SQ.FT. (0.00 AC.)	0.00 SQ.FT. (0.00 AC.)	0.00 SQ.FT. (0.00 AC.)	0.00 CU.YD. (0.00 AC-FT)	0.00 CU.YD. (0.00 AC-FT)	0.00 CU.YD. (0.00 AC-FT)
Area 'B'	641	452.80 SQ.FT. (0.01 AC.)	0.00 SQ.FT. (0.00 AC.)	0.00 SQ.FT. (0.00 AC.)	0.00 SQ.FT. (0.00 AC.)	1100.10 CU.YD. (0.68 AC-FT)	00 CU.YD. (0.00 AC-FT)	187.20 CU.YD. (0.12 AC-FT)
Area 'C'	524	0.00 SQ.FT. (0.00 AC.)	0.00 SQ.FT. (0.00 AC.)	0.00 SQ.FT. (0.00 AC.)	0.00 SQ.FT. (0.00 AC.)	0.00 CU.YD. (0.00 AC-FT)	00 CU.YD. (0.00 AC-FT)	00 CU.YD. (0.00 AC-FT)
Area 'D'	511	29322.52 SQ.FT. (0.67 AC.)	1785.73 SQ.FT. (0.04 AC.)	256.20 SQ.FT. (0.01 AC.)	0.00 SQ.FT. (0.00 AC.)	25732.06 CU.YD. (15.95 AC-FT)	2012.48 CU.YD. (1.25 AC-FT)	8824.81 CU.YD. (8.20 AC-FT)
Area 'E'	618	11291.82 SQ.FT. (0.26 AC.)	0.00 SQ.FT. (0.00 AC.)	0.00 SQ.FT. (0.00 AC.)	0.00 SQ.FT. (0.00 AC.)	16326.93 CU.YD. (10.12 AC-FT)	2295.02 CU.YD. (1.42 AC-FT)	16476.69 CU.YD. (10.21 AC-FT)
Area 'E'	611	14284.50 SQ.FT. (0.33 AC.)	9880.70 SQ.FT. (0.22 AC.)	3005.52 SQ.FT. (0.08 AC.)	0.00 SQ.FT. (0.00 AC.)	12970.80 CU.YD. (8.04 AC-FT)	84718.01 CU.YD. (52.51 AC-FT)	00 CU.YD. (0.00 AC-FT)
Area 'F'	618	4839.41 SQ.FT. (0.11 AC.)	2059.64 SQ.FT. (0.05 AC.)	0.00 SQ.FT. (0.00 AC.)	0.00 SQ.FT. (0.00 AC.)	6223.20 CU.YD. (3.89 AC-FT)	581.25 CU.YD. (0.36 AC-FT)	00 CU.YD. (0.00 AC-FT)
Area 'G'	618	8019.38 SQ.FT. (0.14 AC.)	0.00 SQ.FT. (0.00 AC.)	0.00 SQ.FT. (0.00 AC.)	0.00 SQ.FT. (0.00 AC.)	6212.65 CU.YD. (3.85 AC-FT)	0.00 CU.YD. (0.00 AC-FT)	0.00 CU.YD. (0.00 AC-FT)
Area 'H'	618	9847.00 SQ.FT. (0.23 AC.)	0.00 SQ.FT. (0.00 AC.)	0.00 SQ.FT. (0.00 AC.)	0.00 SQ.FT. (0.00 AC.)	33108.90 CU.YD. (20.52 AC-FT)	.00 CU.YD. (0.00 AC-FT)	.00 CU.YD. (0.00 AC-FT)
TOTALS		93680.83 SQ.FT. (2.15 AC.)	13677.85 SQ.FT. (0.31 AC.)	3921.72 SQ.FT. (0.08 AC.)	0.00 SQ.FT. (0.00 AC.)	62177.65 CU.YD. (38.54 AC-FT)	83.43 CU.YD. (0.05 AC-FT)	1030.86 CU.YD. (0.64 AC-FT)
						88880.19 CU.YD. (101.60 AC-FT)	163912.29 CU.YD. (101.60 AC-FT)	20218.58 CU.YD. (16.25 AC-FT)

APPLICANT: FLORIDA DEPARTMENT OF TRANSPORTATION
(DISTRICT FIVE)

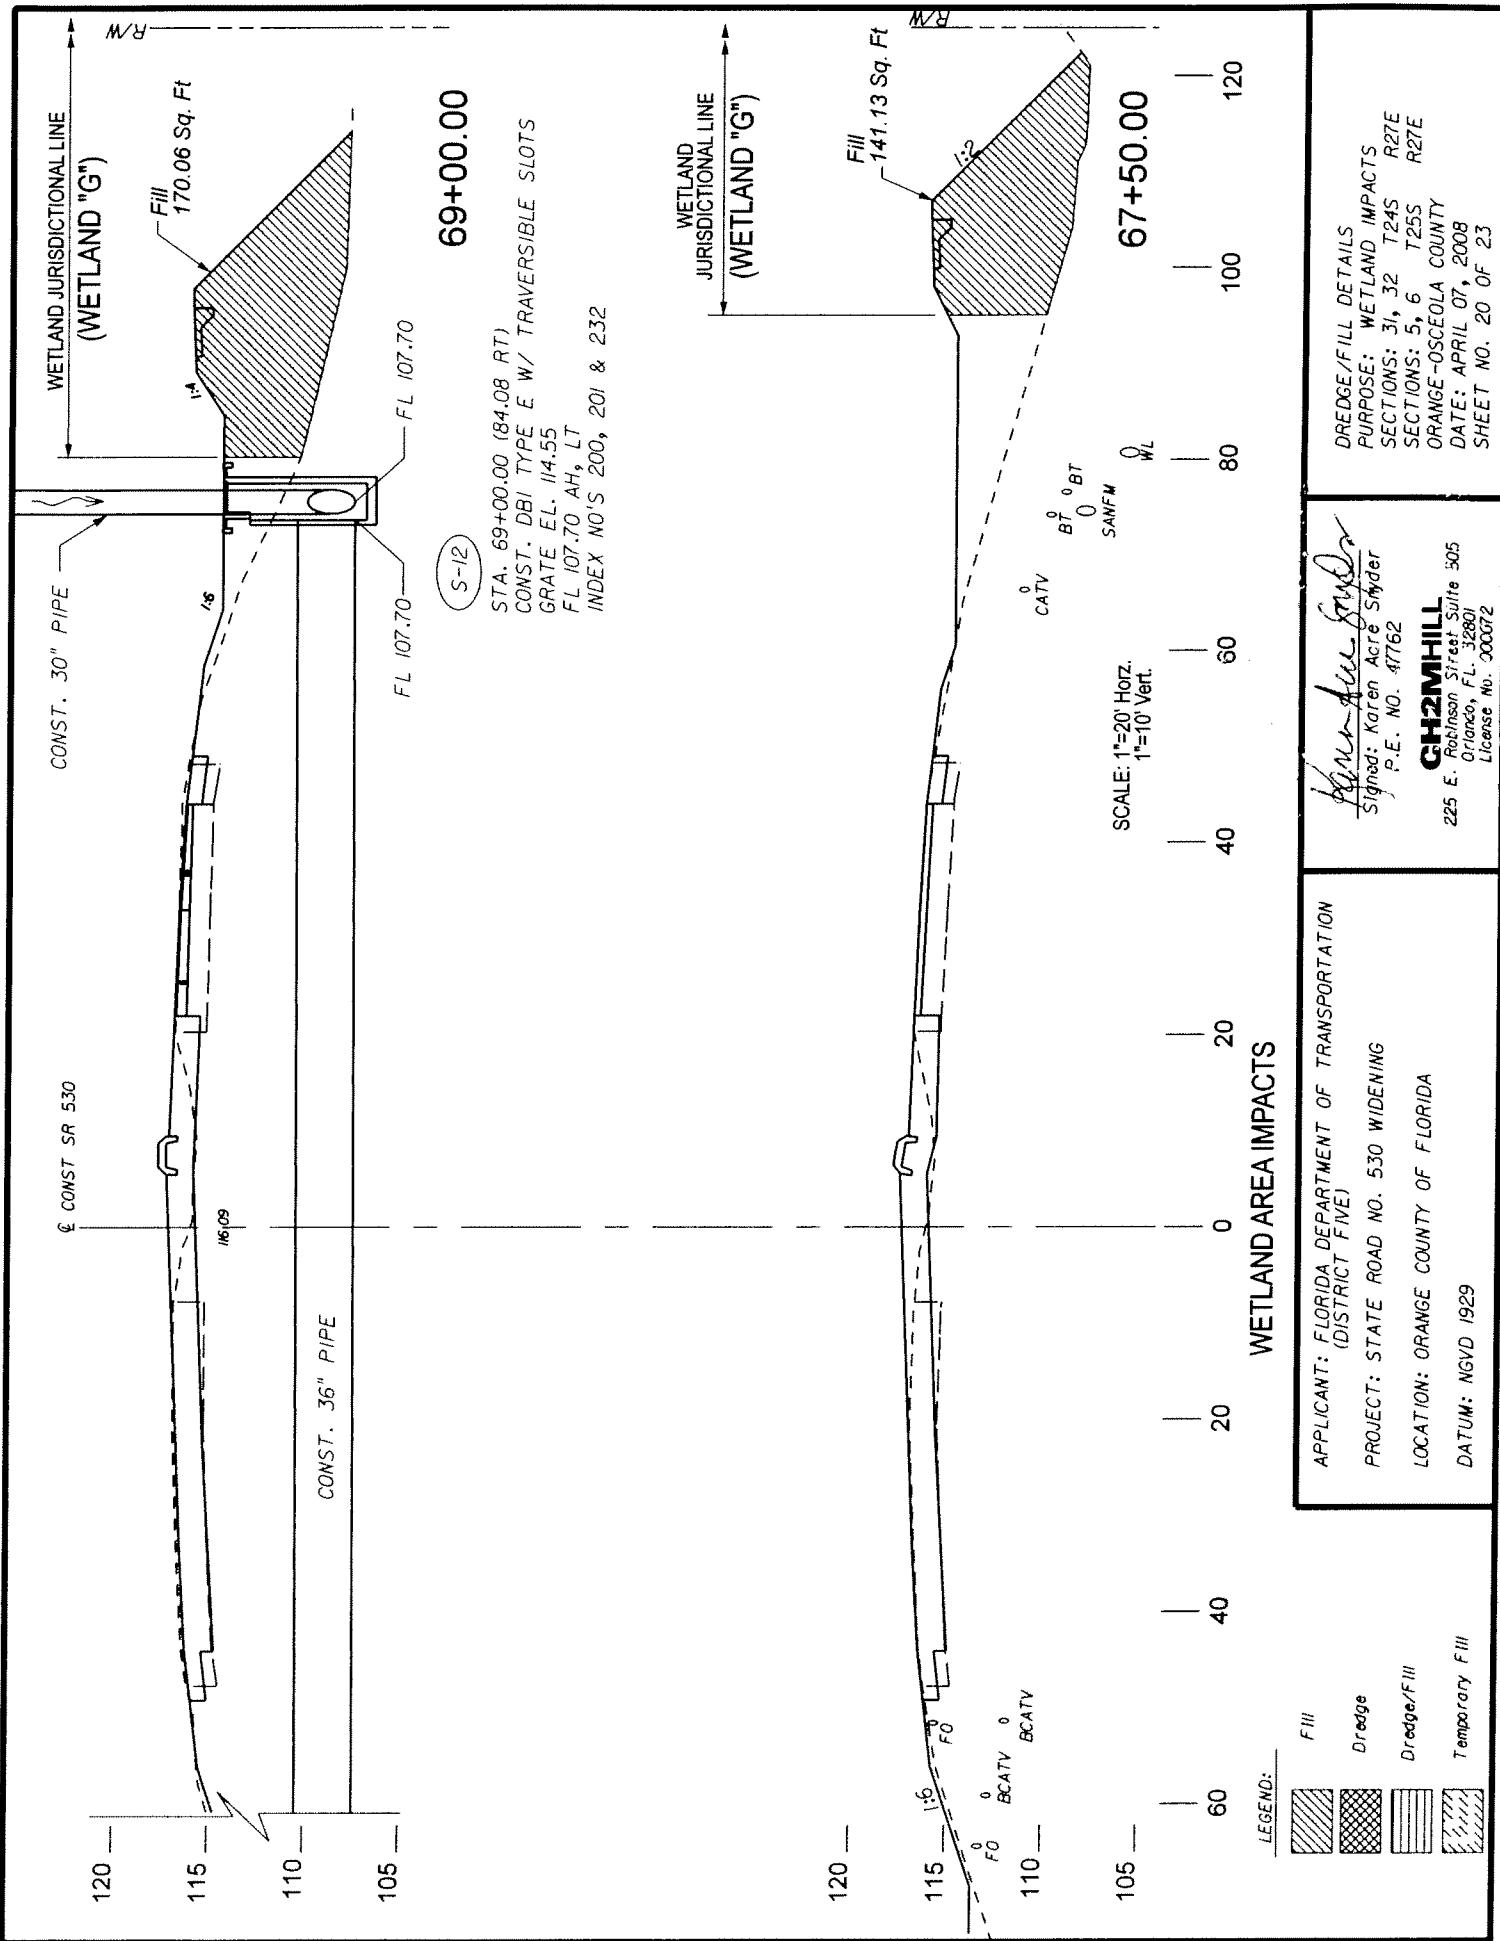PROJECT: STATE ROAD NO. 530 WIDENING

LOCATION: ORANGE COUNTY OF FLORIDA

DATUM: NGVD 1929

John A. Gruber
Signed: Karen Actis
P.E. NC 47762

CH2MHILL
225 E. Robinson Street Suite 505
Orlando, FL 32801
License No. 300072

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April 8, 08

DREDGE/FILL DETAILS
PURPOSE: WETLAND IMPACTS
SECTIONS: 3, 32 T24S R27E
SECTIONS: 5, 6 T25S R27E
ORANGE-OSCEOLA COUNTY
DATE: APRIL 07, 2008
SHEET NO. 23 OF 23



SOUTH FLORIDA WATER MANAGEMENT DISTRICT
ENVIRONMENTAL RESOURCE
PERMIT MODIFICATION NO. 49-00956-P
DATE ISSUED: DECEMBER 2, 2008

PERMITTEE: FLORIDA DEPARTMENT OF TRANSPORTATION DISTRICT 5
(SR 530 (US 192) WIDENING FROM LAKE COUNTY LINE)
719 SOUTH WOODLAND BLVD.
DELAND, FL 32720

ORIGINAL PERMIT ISSUED: MARCH 11, 1999

ORIGINAL PROJECT DESCRIPTION: AUTHORIZATION FOR THE CONSTRUCTION AND OPERATION OF THE SURFACE WATER MANAGEMENT SYSTEM TO SERVE THE 101.68-ACRE US192 (SR530) ROADWAY WIDENING PROJECT, DISCHARGING TO WEST BOGGY CREEK, BLACK LAKE AND REEDY CREEK.

APPROVED MODIFICATION : CONSTRUCTION AND OPERATION OF A SURFACE WATER MANAGEMENT SYSTEM TO SERVE 51.70 ACRES OF A HIGHWAY PROJECT KNOWN AS S.R. 530 (U.S. 192) WIDENING FROM LAKE COUNTY LINE TO SECRET LAKE DRIVE.

PROJECT LOCATION: ORANGE COUNTY, SECTION 31 32 TWP 24S RGF 27E
PROJECT LOCATION: OSCEOLA COUNTY, SECTION 5 6 TWP 25S RGE 27E

PERMIT DURATION: See Special Condition No.1. See attached Rule 40E-4.321, Florida Administrative Code.

This Permit Modification is approved pursuant to Application No. 080409-17, dated April 7, 2008. Permittee agrees to hold and save the South Florida Water Management District and its successors harmless from any and all damages, claims or liabilities which may arise by reason of the construction, operation, maintenance or use of any activities authorized by this Permit. This Permit is issued under the provisions of Chapter 373, Part IV, Florida Statutes(F.S.), and the Operating Agreement Concerning Regulation Under Part IV, Chapter 373 F.S. between South Florida Water Management District and the Department of Environmental Protection. Issuance of this Permit constitutes certification of compliance with state water quality standards where necessary pursuant to Section 401, Public Law 92-500, 33 USC Section 1341, unless this Permit is issued pursuant to the net improvement provisions of Subsections 373.414(1),(b), F.S., or as otherwise stated herein.

This Permit Modification may be revoked, suspended, or modified at any time pursuant to the appropriate provisions of Chapter 373, F.S., and Sections 40E-4.351(1), (2), and (4), Florida Administrative Code (F.A.C.). This Permit Modification may be transferred pursuant to the appropriate provisions of Chapter 373, F.S., and Sections 40E-4.6107(1) and (2), and 40E-4.351(1), (2), and (4), F.A.C.

All specifications and special and limiting/general conditions attendant to the original Permit,unless specifically rescinded by this or previous modifications, remain in effect.

This Permit Modification shall be subject to the Environmental Resource Permit set forth in Rule 40E-4.381, F.A.C., unless waived or modified by the Governing Board. The Application, and Environmental Resource Permit Staff Review Summary of the Application, including all conditions, and all plans and specifications incorporated by reference, are a part of this Permit Modification. All activities authorized by this Permit Modification shall be implemented as set forth in the plans, specifications, and performance criteria as set forth and incorporated in the Environmental Resource Permit Staff Review Summary. Within 30 days after completion of construction of the permitting activity, the Permittee shall submit a written statement of completion and certification by a registered professional engineer or other appropriate individual, pursuant to the appropriate provisions of Chapter 373, F.S. and Sections 40E-4.361 and 40E-4.381, F.A.C.

In the event the property is sold or otherwise conveyed, the Permittee will remain liable for compliance with this Permit until transfer is approved by the District pursuant to Rule 40E-4.6107, F.A.C.

SPECIAL AND GENERAL CONDITIONS ARE AS FOLLOWS:

SEE PAGES 2 - 3 OF 6 (20 SPECIAL CONDITIONS)
SEE PAGES 4 - 5 OF 6 (19 GENERAL CONDITIONS)

PERMIT MODIFICATION APPROVED BY THE GOVERNING BOARD OF THE SOUTH FLORIDA WATER MANAGEMENT DISTRICT

ON _____
BY _____
DEPUTY CLERK

PAGE 1 OF 6

U.S. Army Corps of Engineers
Permit # SAT-1998-4316
Date: 12/15/08
Attachment: 2



SPECIAL CONDITIONS

1. The construction phase of this permit shall expire on December 2, 2013.
2. Operation of the surface water management system shall be the responsibility of FLORIDA DEPARTMENT OF TRANSPORTATION DISTRICT 5.
3. Discharge Facilities:

Basin Basin 1, Pond 1, Structure: S-15
1-10' WIDE BROAD CRESTED weir with crest at elev. 111.5' NGVD 29.
1-3" dia. CIRCULAR ORIFICE with invert at elev. 110.9' NGVD 29.
Receiving body : 50-foot Drainage Easement
Control elev : 110.9 feet NGVD 29.

Basin: Basin 3, Pond 5, Structure: S-16
1-4' WIDE BROAD CRESTED weir with crest at elev. 111' NGVD 29.
1-3" dia. CIRCULAR ORIFICE with invert at elev. 110.25' NGVD 29.
Receiving body : Lake Apache
Control elev : 110.25 feet NGVD 29.
4. The permittee shall be responsible for the correction of any erosion, shoaling or water quality problems that result from the construction or operation of the surface water management system.
5. Measures shall be taken during construction to insure that sedimentation and/or turbidity violations do not occur in the receiving water.
6. The District reserves the right to require that additional water quality treatment methods be incorporated into the drainage system if such measures are shown to be necessary.
7. Lake side slopes shall be no steeper than 6:1 (horizontal:vertical) to a depth of two feet below the control elevation. Side slopes shall be nurtured or planted from 2 feet below to 1 foot above control elevation to insure vegetative growth, unless shown on the plans.
8. Facilities other than those stated herein shall not be constructed without an approved modification of this permit.
9. A stable, permanent and accessible elevation reference shall be established on or within one hundred (100) feet of all permitted discharge structures no later than the submission of the certification report. The location of the elevation reference must be noted on or with the certification report.
10. The permittee shall provide routine maintenance of all of the components of the surface water management system in order to remove all trapped sediments/debris. All materials shall be properly disposed of as required by law. Failure to properly maintain the system may result in adverse flooding conditions.
11. The permittee acknowledges, that pursuant to Rule 40E-4.101(2), F.A.C., a notice of Environmental Resource or Surface Water Management Permit may be recorded in the county public records. Pursuant to the specific language of the rule, this notice shall not be considered an encumbrance upon the property.
12. An average 25' wide, minimum 15', buffer of undisturbed upland vegetation shall be maintained between the proposed development and existing wetlands. Buffers shall be staked and roped and District environmental staff notified for inspection prior to clearing..
13. Silt screens, hay bales, turbidity screens/barriers or other such sediment control measures shall be utilized during construction. The selected sediment control measure shall be installed landward of the upland buffer zones around all

protected wetlands and shall be properly "trenched" etc. All areas shall be stabilized and vegetated immediately after construction to prevent erosion into the wetlands and upland buffer zones.

14. The District reserves the right to require remedial measures to be taken by the permittee if monitoring or other information demonstrates that adverse impacts to onsite or offsite wetlands, upland conservation areas or buffers, or other surface waters have occurred due to project related activities.
15. Endangered species, threatened species and/or species of special concern have been observed onsite and/or the project contains suitable habitat for these species. It shall be the permittee's responsibility to coordinate with the Florida Fish and Wildlife Conservation Commission and/or the U.S. Fish and Wildlife Service for appropriate guidance, recommendations and/or necessary permits to avoid impacts to listed species.
16. Silt fencing shall be installed at the limits of construction to protect all areas from silt and sediment deposition during the construction of the project. The sediment controls shall be installed prior to the commencement of any clearing or construction and shall remain in place and be maintained in good functional condition until all adjacent construction activities have been completed and all fill slopes have been stabilized.
17. The exhibits and special conditions in this permit apply only to this application. They do not supersede or delete any requirements for other applications covered in Permit No. 48-00840-S unless otherwise specified herein.
18. The authorization for construction of the surface water management system is issued pursuant to the water quality net improvement provisions referenced in Rule Section 40E-4.303(1) Florida Administrative Code; therefore, the state water quality certification is waived.
19. Mitigation to offset the proposed 0.63 direct and 2.3 secondary acres of impact has been provided through provisions of Chapter 373.4137 F.S. The final order was issued by FDEP on March 11, 1999, under WPI #5147268 and Mitigation ID #SF05. Mitigation to offset the impacts was originally approved to be through the acquisition of 45 forested bank credits from an appropriate mitigation bank. The 45 credits have been purchased from the Reedy Creek Mitigation Bank and are held by the District.

Previous DOT projects have utilized portions of this credit purchase resulting in a current excess of 1.31 credits. The proposed project will use 0.54 of these excess credits to offset the 2.93 acres of impacts. The remainder of the originally approved forested credits (0.77 credits) will be held by the District for future use to offset appropriate DOT wetland impacts. (Exhibit 3 pages 12-13).

20. The following exhibits for the permit are incorporated by reference herein and are located in the permit file:

Exhibit No. 3 (Pages 17 to 32 of 32) - UMAM Score Sheets

GENERAL CONDITIONS

1. All activities authorized by this permit shall be implemented as set forth in the plans, specifications and performance criteria as approved by this permit. Any deviation from the permitted activity and the conditions for undertaking that activity shall constitute a violation of this permit and Part IV, Chapter 373, F.S.
2. This permit or a copy thereof, complete with all conditions, attachments, exhibits, and modifications shall be kept at the work site of the permitted activity. The complete permit shall be available for review at the work site upon request by District staff. The permittee shall require the contractor to review the complete permit prior to commencement of the activity authorized by this permit.
3. Activities approved by this permit shall be conducted in a manner which does not cause violations of State water quality standards. The permittee shall implement best management practices for erosion and pollution control to prevent violation of State water quality standards. Temporary erosion control shall be implemented prior to and during construction, and permanent control measures shall be completed within 7 days of any construction activity. Turbidity barriers shall be installed and maintained at all locations where the possibility of transferring suspended solids into the receiving waterbody exists due to the permitted work. Turbidity barriers shall remain in place at all locations until construction is completed and soils are stabilized and vegetation has been established. All practices shall be in accordance with the guidelines and specifications described in Chapter 6 of the Florida Land Development Manual: A Guide to Sound Land and Water Management (Department of Environmental Regulation, 1988), incorporated by reference in Rule 40E-4.091, F.A.C., unless a project-specific erosion and sediment control plan is approved as part of the permit. Thereafter the permittee shall be responsible for the removal of the barriers. The permittee shall correct any erosion or shoaling that causes adverse impacts to the water resources.
4. The permittee shall notify the District of the anticipated construction start date within 30 days of the date that this permit is issued. At least 48 hours prior to commencement of activity authorized by this permit, the permittee shall submit to the District an Environmental Resource Permit Construction Commencement Notice Form Number 0960 indicating the actual start date and the expected construction completion date.
5. When the duration of construction will exceed one year, the permittee shall submit construction status reports to the District on an annual basis utilizing an annual status report form. Status report forms shall be submitted the following June of each year.
6. Within 30 days after completion of construction of the permitted activity, the permittee shall submit a written statement of completion and certification by a professional engineer or other individual authorized by law, utilizing the supplied Environmental Resource/Surface Water Management Permit Construction Completion/Certification Form Number 0881A, or Environmental Resource/Surface Water Management Permit Construction Completion Certification - For Projects Permitted prior to October 3, 1995 Form No. 0881B, incorporated by reference in Rule 40E-1.659, F.A.C. The statement of completion and certification shall be based on on-site observation of construction or review of as-built drawings for the purpose of determining if the work was completed in compliance with permitted plans and specifications. This submittal shall serve to notify the District that the system is ready for inspection. Additionally, if deviation from the approved drawings are discovered during the certification process, the certification must be accompanied by a copy of the approved permit drawings with deviations noted. Both the original and revised specifications must be clearly shown. The plans must be clearly labeled as "as-built" or "record" drawings. All surveyed dimensions and elevations shall be certified by a registered surveyor.
7. The operation phase of this permit shall not become effective until the permittee has complied with the requirements of condition (6) above, and submitted a request for conversion of Environmental Resource Permit from Construction Phase to Operation Phase, Form No. 0920, the District determines the system to be in compliance with the permitted plans and specifications; and the entity approved by the District in accordance with Sections 9.0 and 10.0 of the Basis of Review for Environmental Resource Permit Applications within the South Florida Water Management District, accepts responsibility for operation and maintenance of the system. The permit shall not be transferred to such approved operation and maintenance entity until the operation phase of the permit becomes effective. Following inspection and approval of the permitted system by the District, the permittee shall initiate transfer of the permit to the approved responsible operating entity if different from the permittee. Until the permit is transferred pursuant to Section 40E-1.6107, F.A.C., the permittee

shall be liable for compliance with the terms of the permit.

8. Each phase or independent portion of the permitted system must be completed in accordance with the permitted plans and permit conditions prior to the initiation of the permitted use of site infrastructure located within the area served by that portion or phase of the system. Each phase or independent portion of the system must be completed in accordance with the permitted plans and permit conditions prior to transfer of responsibility for operation and maintenance of the phase or portion of the system to a local government or other responsible entity.
9. For those systems that will be operated or maintained by an entity that will require an easement or deed restriction in order to enable that entity to operate or maintain the system in conformance with this permit, such easement or deed restriction must be recorded in the public records and submitted to the District along with any other final operation and maintenance documents required by Sections 9.0 and 10.0 of the Basis of Review for Environmental Resource Permit applications within the South Florida Water Management District, prior to lot or units sales or prior to the completion of the system, whichever comes first. Other documents concerning the establishment and authority of the operating entity must be filed with the Secretary of State, county or municipal entities. Final operation and maintenance documents must be received by the District when maintenance and operation of the system is accepted by the local government entity. Failure to submit the appropriate final documents will result in the permittee remaining liable for carrying out maintenance and operation of the permitted system and any other permit conditions.
10. Should any other regulatory agency require changes to the permitted system, the permittee shall notify the District in writing of the changes prior to implementation so that a determination can be made whether a permit modification is required.
11. This permit does not eliminate the necessity to obtain any required federal, state, local and special district authorizations prior to the start of any activity approved by this permit. This permit does not convey to the permittee or create in the permittee any property right, or any interest in real property, nor does it authorize any entrance upon or activities on property which is not owned or controlled by the permittee, or convey any rights or privileges other than those specified in the permit and Chapter 40E-4 or Chapter 40E-40, F.A.C..
12. The permittee is hereby advised that Section 253.77, F.S. states that a person may not commence any excavation, construction, or other activity involving the use of sovereign or other lands of the State, the title to which is vested in the Board of Trustees of the Internal Improvement Trust Fund without obtaining the required lease, license, easement, or other form of consent authorizing the proposed use. Therefore, the permittee is responsible for obtaining any necessary authorizations from the Board of Trustees prior to commencing activity on sovereignty lands or other state-owned lands.
13. The permittee must obtain a Water Use permit prior to construction dewatering, unless the work qualifies for a general permit pursuant to Subsection 40E-20.302(3), F.A.C. also known as the "No Notice" Rule.
14. The permittee shall hold and save the District harmless from any and all damages, claims, or liabilities which may arise by reason of the construction, alteration, operation, maintenance, removal, abandonment or use of any system authorized by the permit.
15. Any delineation of the extent of a wetland or other surface water submitted as part of the permit application, including plans or other supporting documentation, shall not be considered binding, unless a specific condition of this permit or a formal determination under Section 373.421(2), F.S., provides otherwise.
16. The permittee shall notify the District in writing within 30 days of any sale, conveyance, or other transfer of ownership or control of a permitted system or the real property on which the permitted system is located. All transfers of ownership or transfers of a permit are subject to the requirements of Rules 40E-1.6105 and 40E-1.6107, F.A.C.. The permittee transferring the permit shall remain liable for corrective actions that may be required as a result of any violations prior to the sale, conveyance or other transfer of the system.
17. Upon reasonable notice to the permittee, District authorized staff with proper identification shall have permission to enter, inspect, sample and test the system to insure conformity with the plans and specifications approved by the permit.

18. If historical or archaeological artifacts are discovered at any time on the project site, the permittee shall immediately notify the appropriate District service center.
19. The permittee shall immediately notify the District in writing of any previously submitted information that is later discovered to be inaccurate.

ENVIRONMENTAL RESOURCE PERMITS CHAPTER 40E-4 (01/07)

40E-4.321 Duration of Permits

(1) Unless revoked or otherwise modified the duration of an environmental resource permit issued under this chapter or Chapter 40E-40, F.A.C., is as follows:

(a) For a conceptual approval, two years from the date of issuance or the date specified as a condition of the permit, unless within that period an application for an individual or standard general permit is filed for any portion of the project. If an application for an environmental resource permit is filed, then the conceptual approval remains valid until final action is taken on the environmental resource permit application. If the application is granted, then the conceptual approval is valid for an additional two years from the date of issuance of the permit. Conceptual approvals which have no individual or standard general environmental resource permit applications filed for a period of two years shall expire automatically at the end of the two year period.

(b) For a conceptual approval filed concurrently with a development of regional impact (DRI) application for development approval (ADA) and a local government comprehensive plan amendment, the duration of the conceptual approval shall be two years from whichever one of the following occurs at the latest date:

1. The effective date of the local government's comprehensive plan amendment,
2. The effective date of the local government development order,

3. The date on which the District issues the conceptual approval, or 4. The date on which the District issues a final order pertaining to the resolution of any Section 120.57, F.S., administrative proceeding or other legal appeals.

(c) For an individual or standard general environmental resource permit, the construction phase authorizing construction, removal, alteration or abandonment of a system shall expire five years from the date of issuance or such amount of time as made a condition of the permit.

(d) For an individual or standard general environmental resource permit, the operational phase of the permit is perpetual for operation and maintenance.

(e) For a noticed general permit issued pursuant to Chapter 40E-400, F.A.C., five years from the date the notice of intent to use the permit is provided to the District.

(2)(a) Unless prescribed by special permit condition, permits expire automatically according to the timeframes indicated in this rule. If application for extension is made by electronic mail at the District's e-Permitting website or in writing pursuant to subsection (3), the permit shall remain in full force and effect until:

1. The Governing Board takes action on an application for extension of an individual permit, or
2. Staff takes action on an application for extension of a standard general permit.

(b) Installation of the project outfall structure shall not constitute a vesting of the permit.

(3) The permit extension shall be issued provided that a permittee files a written request with the District showing good cause prior to the expiration of the permit. For the purpose of this rule, good cause shall mean a set of extenuating circumstances outside of the control of the permittee. Requests for extensions, which shall include documentation of the extenuating circumstances and how they have delayed this project, will not be accepted more than 180 days prior to the expiration date.

(4) Substantial modifications to Conceptual Approvals will extend the duration of the Conceptual Approval for two years from the date of issuance of the modification. For the purposes of this section, the term "substantial modification" shall mean a modification which is reasonably expected to lead to substantially different water resource or environmental impacts which require a detailed review.

(5) Substantial modifications to individual or standard general environmental resource permits issued pursuant to a permit application extend the duration of the permit for three years from the date of issuance of the modification. Individual or standard general environmental resource permit modifications do not extend the duration of a conceptual approval.

(6) Permit modifications issued pursuant to paragraph 40E-4.331(2)(b), F.A.C. (letter modifications) do not extend the duration of the permit.

(7) Failure to complete construction or alteration of the surface water management system and obtain operation phase approval from the District within the permit duration shall require a new permit authorization in order to continue construction unless a permit extension is granted.

Specific Authority 373.044, 373.113, 668.003, 668.004, 668.50 FS. Law Implemented 373.413, 373.416, 373.419, 373.426, 668.003, 668.004, 668.50 FS. History- New 9-3-81. Amended 1-31-82, 12-1-82, Formerly 16K-4.07(4), Amended 7-1-86, 4-20-94, 10-3-95, 5-28-00, 10-1-06.

AS-BUILT CERTIFICATION BY PROFESSIONAL ENGINEER

Submit this form and one set of as-built engineered drawings to the U.S. Army Corps of Engineers, Enforcement Branch, Post Office Box 4970, Jacksonville, Florida 32232-0019. If you have questions regarding this requirement, please contact the Enforcement Branch at 904-232-2907.

1. Department of the Army Permit Number: _____
2. Permittee Information:

Name _____

Address _____

3. Project Site Identification:

Physical location/address _____

4. As-Built Certification:

I hereby certify that the authorized work has been accomplished in accordance with the Department of the Army permit with any deviations noted below. This determination is based upon on-site observation, scheduled and conducted by me or by a project representative under my direct supervision. I have enclosed one set of as-built engineering drawings.

Signature of Engineer

Name (Please type)

Florida Reg. Number

Company Name

Address

(Affix Seal)

City State ZIP

Date

Telephone Number

Deviations from the approved plans and specifications: (attach additional pages if necessary)

U.S. Army Corps of Engineers
Permit # SAT-1998-4316
Date: 12/08/08
Attachment: 3

